


## **PROPERTY IDENTIFICATION**

ebruary 12, 2024 9:36 AM K:\2022\220002.00.02 The Commons Club -Pickleball Redesign\03 Civil Design And Construction Plans\Current Plans\Sheet Files\01 2200020100C CS01.dwg


STRAP: 10-47-25-E3-42120.1982

# LIMITED DEVELOPMENT ORDER AMENDMENT PLANS FOR $\Delta$ THE COMMONS CLUB AT THE BROOKS **PICKLEBALL FACILITY EXPANSION**

PART OF SECTION 10, TOWNSHIP 47S, RANGE 25E, LEE, FLORIDA PREPARED FOR/OWNED BY: THE COMMONS CLUB AT THE BROOKS, INC. 9920 COCONUT RD. ESTERO, FLORIDA 34135 (239) 949 - 3804

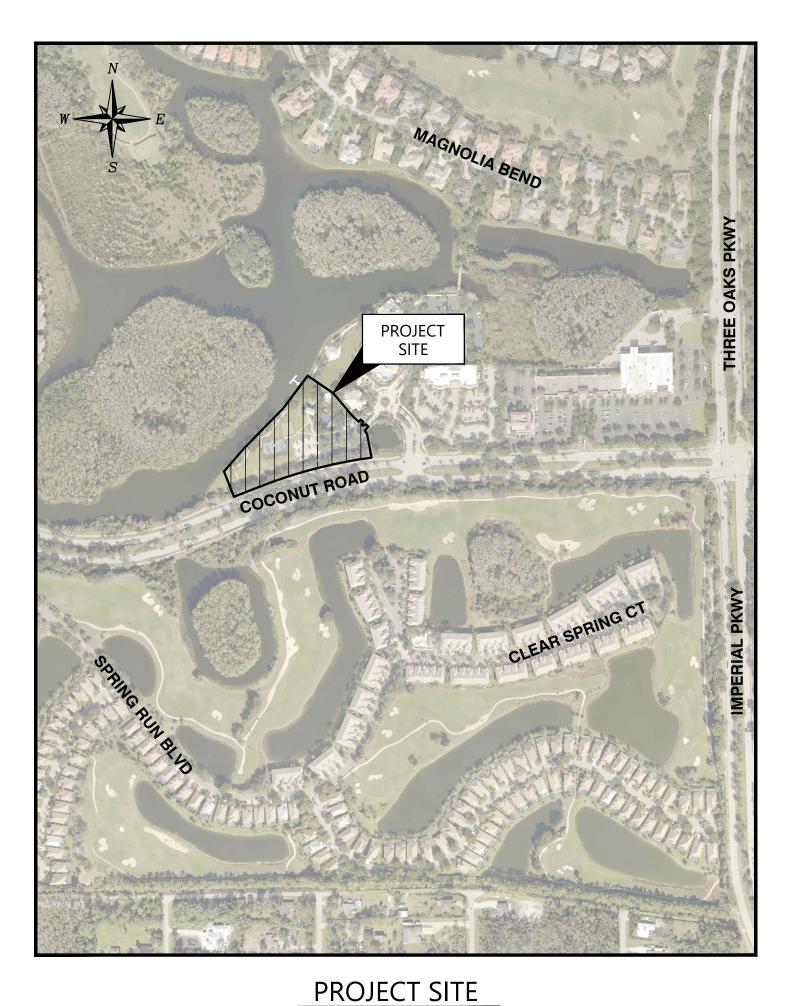

N.T.S.

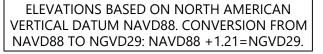



# **SHEET INDEX**

Sheet Number	Sheet Title
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REVISIONS							
No.:	DATE:		DESCRIPTION:		APPROVED:		
	01/20/23	REVISED PER SFWMD & VC	DE COMMENTS		МСР		
⚠	04/17/23	REVISED PER VOE COMME	NTS		МСР		
<u>_3</u>	05/08/23	REVISED COURT FENCING			МСР		
4	05/24/23	REVISED PER PZDB STIPUL	ATIONS AND CLIENT		МСР		
ß	07/07/32	REVISED PER CLIENT			МСР		
6	01/17/24	CHANGED CLIENT AND RE	VISED COURT CONSTRUCTION		МСР		
			6610 Willow Park Drive Suite 200 Naples, FL 34109 12800 University Drive Suite 175 Fort Myers, FL 33907 19503 S West Villages Pkwy Unit A5 Venice, FL 34293 Office: (239) 597-0575 Fax: (239) 597-0578 www.consult-rwa.com Florida Certificates of Authorization EB 7663 LB 6952	ENGINEER'S SEAL: MICHAEL C. PAPPAS, LICENSE NO. 60 STATE OF FLOR CERTIFICATE NO	910 RWA, INC. IDA BUSINESS		
DATE:							

GENERAL NOTES:	WATER, SEWER AND NON-POTABLE IRRIGATION NOTES:
1. ALL ELEVATIONS REFERENCED WITHIN THIS PLAN SET ARE NORTH AMERICAN VERTICAL DATUM NAVD 88, UNLESS OTHERWISE STATED. CONVERSION TO THE NATIONAL GEODETIC VERTICAL DATUM OF 1929 (NGVD 29) IS +1.21.	1. ALL WATER, SEWER AND NON-POTABLE IRRIGATION CONSTRUCTION SHALL CONFORM T 2. THE CONTRACTOR SHALL NOTIFY BONITA SPRINGS UTILITIES (BSU) AND THE ENGINEER 4
<ol> <li>THE CONTRACTOR SHALL BE RESPONSIBLE FOR COORDINATION WITH ANY OTHER CONTRACTORS WHO MAY BE PERFORMING WORK AT THE PROJECT SITE.</li> <li>THE LOCATION OF EXISTING UNDERGROUND UTILITIES ARE SHOWN IN AN APPROXIMATE WAY ONLY. THE CONTRACTOR SHALL DETERMINE THE EXACT LOCATION, SIZE AND TYPE OF ALL EXISTING UTILITIES BEFORE COMMENCING WORK. THE CONTRACTOR AGREES TO BE FULLY RESPONSIBLE FOR ANY AND ALL DAMAGES WHICH MIGHT BE OCCASIONED BY HIS FAILURE TO EXACTLY LOCATE AND PRESERVE ANY AND ALL UNDERGROUND UTILITIES.</li> </ol>	<ul> <li>FLUSHING, TESTING, SAMPLING OR CONNECTION TO EXISTING SYSTEMS.</li> <li>3. ALL CONNECTIONS TO EXISTING MAINS SHALL BE MADE BY THE CONTRACTOR ONLY AFT HAS BEEN REVIEWED AND APPROVED BY LEE COUNTY. THE CONTRACTOR SHALL NOTIFY CONNECTION.</li> </ul>
<ol> <li>EXISTING FACILITIES SHALL BE RESTORED TO A CONDITION EQUIVALENT TO THAT WHICH EXISTED PRIOR TO COMMENCEMENT OF CONSTRUCTION. NO SEPARATE PAYMENT WILL BE MADE FOR THIS WORK.</li> <li>THE CONTRACTOR SHALL KEEP AND MAINTAIN ON SITE AN ACCURATE UP-TO-DATE SET OF AS-BUILT DRAWINGS. THESE DRAWINGS SHALL INCLUDE LOCATIONS AND ELEVATIONS OF MAINS, FITTINGS, VALVES, SERVICES, CASINGS AND OTHER APPURTENANCES AS WELL AS ANY DEVIATIONS IN THE PLANS. THESE AS-BUILT DRAWINGS SHALL BE SUBMITTED TO THE OWNER'S REPRESENTATIVE UPON COMPLETION OF THE WORK FOR HIS REVIEW AND USE.</li> <li>THE CONTRACTOR SHALL BE RESPONSIBLE FOR OBTAINING ALL REQUIRED CITY, COUNTY, STATE OR LOCAL CONSTRUCTION PERMITS OR APPROVALS ETC., AND POSTING ALL REQUIRED BONDS, ETC. PRIOR TO BEGINNING CONSTRUCTION. THE CONTRACTOR SHALL COORDINATE ALL REQUIRED INSPECTIONS WITH UTILITY COMPANIES, CITY, COUNTY OR STATE AGENCIES AND THE OWNER'S REPRESENTATIVE.</li> </ol>	<ol> <li>CROSSOVER AND SEPARATION REQUIREMENTS:         <ol> <li>SHALL CONFORM TO THE REQUIREMENTS OF THE LOCAL UTILITY AUTHORITY AND SUNCLUDING CHAPTER 62-555.314 OF THE FAC.</li> <li>ONE FULL LENGTH OF WATER MAIN PIPE SHALL BE CENTERED ABOVE OR BELOW THE AS FAR AS POSSIBLE FROM THE OTHER PIPELINE:</li> <li>GRAVITY SANITARY SEWERS OR PRESSURE WASTEWATER FORCE MAINS WITH LESS T D. STORM SEWER WITH LESS THAN THREE FEET VERTICAL CLEARANCE.</li> </ol> </li> </ol>
<ol> <li>THE CONTRACTOR SHALL BE RESPONSIBLE FOR MAINTENANCE OF TRAFFIC IN ACCORDANCE WITH CITY, COUNTY AND STATE REQUIREMENTS.</li> <li>THE CONTRACTOR SHALL NOTIFY THE OWNER'S REPRESENTATIVE AND ALL UTILITY COMPANIES IN THE AREA 48 HOURS (MINIMUM) BEFORE BEGINNING CONSTRUCTION.</li> <li>THE CONTRACTOR SHALL MAINTAIN COPIES OF ALL APPLICABLE PERMITS ON-SITE AND SHALL BE RESPONSIBLE TO ADHERE TO ALL PERMIT CONDITIONS DURING CONSTRUCTION.</li> <li>SUBJECT PROPERTY LIES WITHIN FEMA FLOOD ZONE "AH/X" PER FLOOD INSURANCE RATE MAPS, MAP NUMBER 12071C0593G, DATED 12/07/2018.</li> <li>TRASH COLLECTION WILL BE HANDLED VIA EXISTING FACILITIES.</li> </ol>	<ol> <li>WATER SYSTEM NOTES (WM):</li> <li>A. PVC WATER PIPE 4-INCH THROUGH 12-INCH DIAMETER SHALL CONFORM TO THE RE SHALL BE MECHANICAL JOINT DUCTILE IRON CONFORMING TO AWWA C-110,350 PS</li> <li>B. PVC WATER PIPE 6-INCH THROUGH 12-INCH DIAMETER UNDER ROADWAY PAVEMEN OF DUCTILE IRON (CLASS 250) UNLESS SHOWN OTHERWISE ON PLANS.</li> <li>C. WATER SERVICE PIPE 2-INCH DIAMETER AND SMALLER SHALL BE POLYETHYLENE PIPI AWWA C-901. PLACE PIPE IN SCHEDULE 40 PVC CASING UNDER PAVED AREAS.</li> </ol>
<ul> <li>DEMOLITION NOTES:         <ul> <li>CONTRACTOR SHALL REMOVE EXISTING STRUCTURES, BUILDINGS, PILES, AND OTHER FEATURES WITHIN THE LIMITS OF THE PROJECT BOUNDARY. THIS SHALL INCLUDE CONCRETE PADS, FENCING UTILITY SERVICES, etc</li></ul></li></ul>	<ul> <li>D. WATER DISTRIBUTION LINES SHALL HAVE A 3-FOOT MINIMUM COVER FROM FINISHE</li> <li>E. CONTRACTOR IS RESPONSIBLE FOR MAINTAINING THE GENERAL ALIGNMENT OF THE APPLICABLE.</li> <li>F. ALL PVC PIPE USED FOR POTABLE WATER SHALL BE COLORED BLUE.</li> <li>G. ALL WATER METERS SHALL CONFORM TO AWWA C-700 OR NSF 61 STANDARDS.</li> <li>H. BACKFLOW PREVENTER ASSEMBLIES SHALL CONFORM TO AWWA-14 STANDARDS.</li> <li>I. FIRE HYDRANT ASSEMBLIES SHALL CONFORM TO AWWA C-502 STANDARDS.</li> <li>6. GRAVITY SEWER PIPE NOTES: <ul> <li>A. PVC GRAVITY SEWER PIPE AND FITTINGS 4-INCH THROUGH 15-INCH DIAMETER SHA 26 (MIN.) AND SHALL BE GREEN IN COLOR.</li> </ul> </li> <li>7. NON-POTABLE IRRIGATION PIPE NOTES (IM): <ul> <li>A. PVC IRRIGATION PIPE 4-INCH DIAMETER AND LARGER LOCATED IN NON-PAVED ARE. DR 18 (PRESSURE CLASS 150). FITTINGS SHALL BE MECHANICAL JOINT DUCTILE IRON.</li> <li>B. PVC IRRIGATION PIPE 3-INCH DIAMETER SHALL CONFORM TO THE REQUIREMENTS C</li> <li>C. IRRIGATION SERVICE PIPE 2-INCH DIAMETER AND SMALLER SHALL BE POLYETHYLENE TO AWWA C-901. PLACE PIPE IN SCHEDULE 40 PVC CASING UNDER PAVED AREAS.</li> <li>D. IRRIGATION DISTRIBUTION LINES SHALL HAVE A 3-FOOT MINIMUM COVER FROM FIN E. CONTRACTOR IS RESPONSIBLE FOR MAINTAINING THE GENERAL ALIGNMENT OF THE APPLICABLE.</li> <li>F. CONFLICTS BETWEEN IRRIGATION AND STORM OR SEWER LINES AND STRUCTURES A NECESSARY UPON APPROVAL BY THE ENGINEER.</li> <li>G. ALL PVC PIPE AND SERVICE TUBING USED FOR IRRIGATION SHALL BE COLORED PURP</li> </ul> </li> </ul>
<ol> <li>AIL PAVING, GRADING AND DRAINAGE CONSTRUCTION SHALL CONFORM TO THE REQUIREMENTS OF VILLAGE OF ESTERO.</li> <li>ALL PIPE LENGTHS ARE PLUS OR MINUS AND ARE MEASURED FROM CENTER OF STRUCTURES UNLESS SHOWN OTHERWISE.</li> <li>THE CONTRACTOR IS RESPONSIBLE FOR ADJUSTMENTS OF VALVE BOX COVERS, MANHOLE RIMS AND COVER, GRATES, ETC., NECESSARY TO MATCH FINAL GRADES AS SHOWN ON PLANS.</li> <li>ALL UNPAVED AREAS DISTURBED DURING CONSTRUCTION SHALL BE GRASSED AND MULCHED UNLESS OTHERWISE SHOWN ON THE PLANS OR DETAILS.</li> <li>EXISTING OFF-SITE DRAINAGE PATTERNS SHALL BE MAINTAINED DURING CONSTRUCTION.</li> <li>CONFLICTS BETWEEN WATER AND STORM DRAINAGE ARE TO BE RESOLVED BY ADJUSTING WATER LINES AS NECESSARY UPON APPROVAL BY OWNER'S REPRESENTATIVE.</li> <li>PROPOSED PAVERS SHALL BE PRIVATELY MAINTAINED. XXX ITS SUCCESSORS AND/ OR ASSIGNS, SHALL REPAIR AND/ OR REPLACE PAVERS THAT ARE DAMAGED BY XXX DURING MAINTENANCE, REPARE AND COUNTY A MINIMUM OF 48 HOURS BEFORE EACH OF THE FOLLOWING PHASES OF CONSTRUCTION WILL BE READY FOR THE REQUIRED INSPECTIONS:         <ul> <li>A. DRAINAGE PIPE AFTER PLACEMENT AND PIPE JOINTS ARE SEALED AND BEFORE BACKFILLING;</li> <li>HEADWALL FOOTNINGS;</li> <li>SUBGRADE;</li> <li>DRAINE;</li> <li>F. EACH SURFACE COURSE;</li> <li>GONTRACTOR SHALL MAINTAIN THE PREVIOUSLY INSTALLED SILT FENCE.</li> </ul> </li> <li>CONTRACTOR SHALL MAINTAIN THE PREVIOUSLY INSTALLED SILT FENCE.</li> <li>CONTRACTOR SHALL MAINTAIN THE PREVIOUSLY INSTALLED SILT FENCE.</li> <li>ONTRACTOR SHALL MAINTAIN THE PREVIOUSLY INSTALLED SILT FENCE.</li> <li>CONTRACTOR SHALL MAINTAIN THE PREVIOUSLY INSTALLED SILT FENCE.</li> <li>ONTRACTOR SHALL MAINT</li></ol>	<ul> <li>EXISTING VEGETATION AND CONSERVATION NOTES:</li> <li>PRIOR TO COMMENCEMENT OF CONSTRUCTION, ALL EXISTING NATIVE VEGETATION NOT BE PRESERVED. THE CONTRACTOR SHALL INSTALL ENVIROFENCE (OR EQUAL) BEYOND T LIMITS OF CLEARING. THIS FENCE SHALL REMAIN ERECTED &amp; MAINTAINED THROUGH TH</li> <li>ALL EXOTIC VEGETATION AS DEFINED BY COUNTY SHALL BE REMOVED FROM THE SITE F SHALL BE RESPONSIBLE FOR THE SUBSEQUENT ANNUAL REMOVAL OF ALL EXOTIC VEGE</li> <li>SIGNAGE SHALL BE PLACED AROUND PRESERVE AREA TO IDENTIFY AND PROTECT PRESE</li> <li>EXISTING NATIVE VEGETATION LOCATED WITHIN THE DEVELOPABLE AREA AND NOT CLE BARRICADES. BARRICADES WILL REMAIN IN PLACE UNTIL COMPLETION OF CONSTRUCTI</li> </ul>

$\bigtriangleup$	CHANGED CLIENT AND REVISED COURT CONSTRUCTION	HGD	MCP	01/17/24	ENGINEERING
REV #	REVISION	DRAWN	CHECKED	DATE	ENGINEERING

January 17, 2024 10:15 AM K:\2022\220002.00.02 The Commons Club -Pickleball Redesign\03 Civil Design And Construction Plans\Current Plans\Sheet Files\02 2200020100C GN01.dwg

ND NON-POTABLE IRRIGATION CONSTRUCTION SHALL CONFORM TO THE REQUIREMENTS OF BONITA SPRINGS UTILITIES (BSU).	(UNLE	SS OTHERWISE SHOWN, ABBREVIATIONS AND SYMBOLS AF	E SET OU	T IN FDOT STANDARD INDEX - FY 2020-21)
HALL NOTIFY BONITA SPRINGS UTILITIES (BSU) AND THE ENGINEER 48 HOURS IN ADVANCE PRIOR TO ANY UTILITY CONSTRUCTION, SAMPLING OR CONNECTION TO EXISTING SYSTEMS.	AD	AREA DRAIN / ATRIUM DRAIN	ID	INSIDE DIAMETER
	ADA	AMERICAN WITH DISABILITIES ACT	INV	INVERT ELEVATION
	AE	ACCESS EASEMENT	IRRG	IRRIGATION
	ARV	AIR RELEASE VALVE	LBE	LANDSCAPE BUFFER EASEMENT
	BFP	BACKFLOW PRENVENTER	LCEC	LEE COUNTY ELECT. COOPERATIVE
	BL	BASE LINE	LME	LAKE MAINTENANCE EASEMENT
	BOV BOC	BLOW-OFF VALVE BACK OF CURB	LP LL or h	LOW POINT LOT LINE
	вот	BOTTOM	LT	LEFT
IBLE FROM THE OTHER PIPELINE:	BOW	BOTTOM OF WALL	LF	LINEAR FEET
	CAP	CORRUGATED ALUMINUM PIPE	MH	MANHOLE
VITH LESS THAN THREE FEET VERTICAL CLEARANCE.	CATV CE	CABLE TV CONTROL ELEVATION	MJ MES	MECHANICAL JOINT FITTING MITERED END SECTION
ES (WM):	CIP	CAST IN PLACE	NAVD	NORTH AMERICAN VERT. DATUM
	CJ	CONTROL JOINT	NEIE	NORTH EAST INVERT ELEVATION
ANICAL JOINT DUCTILE IRON CONFORMING TO AWWA C-110,350 PSI MINIMUM PRESSURE RATING.		CENTER LINE		NATIONAL GEODETIC VERT. DATUM
6-INCH THROUGH 12-INCH DIAMETER UNDER ROADWAY PAVEMENT BY DIRECT BURY SHALL CONFORM TO THE REQUIREMENTS	CLR CAP	CLEAR CORRUGATED ALUMINUM PIPE	NIC	NOT IN CONTRACT ON CENTER
	CAP CMP	CORRUGATED ALOMINOM PIPE	OC OD	OUTSIDE DIAMETER
	CMU	CONCRETE MASONRY UNIT	PC	POINT OF CURVATURE
ACE PIPE IN SCHEDULE 40 PVC CASING UNDER PAVED AREAS.	CO	CLEAN OUT	PIV	POST INDICATOR VALVE
JTION LINES SHALL HAVE A 3-FOOT MINIMUM COVER FROM FINISHED GRADE.	CS	CONTROL STRUCTURE		PROPERTY LINE
RESPONSIBLE FOR MAINTAINING THE GENERAL ALIGNMENT OF THE WATER LINE BY USING JOINT DEFLECTION OR BENDS AS	CUE	LEE COUNTY UTILITY EASEMENT	PP	POWER POLE
	DE DIP	DRAINAGE EASEMENT DUCTILE IRON PIPE	PSP PT	PERMANENT SAMPLE POINT POINT OF TANGENCY
	DN	DOWN	PUE	PUBLIC UTILITY EASEMENT
	DOT	DEPART. OF TRANSPORTATION	PV	PLUG VALVE
LINILINAJJLINDELIJ JHALL COM ONIM TO ANIMA- 14 JIANDANDJ.	DIA	DIAMETER	PVC	POLY VINYL CHLORIDE PIPE
SSEMBLIES SHALL CONFORM TO AWWA C-502 STANDARDS.	DR	DIMENSION RATIO	PVCF	POLYVINYL CHLORIDE FENCE
NOTES:	EJ FI	EXPANSION JOINT ELEVATION	PVI PS	POINT OF VERT. INTERSECTION PUMP STATION
	ELEC	ELECTRICAL	RCP	REINFORCED CONCRETE PIPE
HALL BE GREEN IN COLOR.	ELEV	ELEVATION	RT	RIGHT
	EOP	EDGE OF PAVEMENT		RECLAIMED WATER MAIN
	EOW ERCP	EDGE OF WATER ELLIPTICAL REINF. CONC. PIPE	RM ROW	REUSE MAIN
E CLASS 150). FITTINGS SHALL BE MECHANICAL JOINT DUCTILE IRON.	FCD	FIRE CONTROL DISTRICT	R/W	RIGHT OF WAY RIGHT OF WAY
	FDC	FIRE DEPARTMENT CONNECTION	(X')R	RADIUS
	FDOT	FLORIDA DEPT. OF TRANSPORT.	S/W	SIDEWALK
	FFE FH	FINISHED FLOOR ELEVATION FIRE HYDRANT	SWLK	SIDEWALK SANITARY SEWER
FRIBUTION LINES SHALL HAVE A 3-FOOT MINIMUM COVER FROM FINISHED GRADE.	FI	FLOW LINE	SS STA	STATION
RESPONSIBLE FOR MAINTAINING THE GENERAL ALIGNMENT OF THE IRRIGATION LINE BY USING JOINT DEFLECTION OR BENDS AS	FM	FORCE MAIN	STR	STORM STRUCTURE
		FOUNDATION	TBF	TEMPORARY BACKFLOW
VEEN IRRIGATION AND STORM OR SEWER LINES AND STRUCTURES ARE TO BE RESOLVED BY ADJUSTING IRRIGATION LINES AS	FOC	FACE OF CURB	TBO	TEMP. BLOW-OFF ASSEMBLY
N APPROVAL BY THE ENGINEER.	FPL FRCP	FLORIDA POWER & LIGHT FIBER REINFORCED CONC. PIPE	TBR TEMP	TO BE REMOVED TEMPORARY
ID SERVICE TUBING USED FOR IRRIGATION SHALL BE COLORED PURPLE.	GALV	GALVANIZED	TBSP	TEMP. BACTERIAL SAMPLE POINT
	GE	GRATE ELEVATION	TOB	TOP OF BANK
TATION AND CONSERVATION NOTES:	GV	GATE VALVE	TOS	TOE OF SLOPE
ICEMENT OF CONSTRUCTION, ALL EXISTING NATIVE VEGETATION NOT WITHIN THE LIMITS OF CONSTRUCTION SHALL BE FLAGGED TO	HDPE HP	HIGH DENSITY POLYETHYLENE HIGH POINT	TOW	TOP OF WALL TEMPORARY SAMPLE POINT
CONTRACTOR SHALL INSTALL ENVIROFENCE (OR EQUAL) BEYOND THE DRIPLINES OF THE RETAINED VEGETATION AND ALONG THE		HIGH POINT	TSP TYP.	TYPICAL
G. THIS FENCE SHALL REMAIN ERECTED & MAINTAINED THROUGH THE DURATION OF THE CONSTRUCTION ACTIVITIES.			UNO	UNLESS NOTED OTHERWISE
TION AS DEFINED BY COUNTY SHALL BE REMOVED FROM THE SITE PRIOR TO PRELIMINARY ACCEPTANCE. THE PROPERTY OWNER			VG	VALLEY GUTTER
IBLE FOR THE SUBSEQUENT ANNUAL REMOVAL OF ALL EXOTIC VEGETATION, IN PERPETUITY.			WM	WATER MAIN
PLACED AROUND PRESERVE AREA TO IDENTIFY AND PROTECT PRESERVE AREA. S.F.W.M.D. SIGNAGE STANDARDS SHALL BE USED.			YD	YARD DRAIN
EGETATION LOCATED WITHIN THE DEVELOPABLE AREA AND NOT CLEARED AS PART OF THIS PERMIT SHALL BE PROTECTED WITH				
CADES WILL REMAIN IN PLACE UNTIL COMPLETION OF CONSTRUCTION.				

STANDARD ABBREVIATIONS:


### "Call Before You Dig"

Call <u>Sunshine State One Call</u>, at 811 or 800-432-4770, two full days before digging in any easement, right-of-way or permitted use area.

12000 Oniversity Drive, Suite 175	date: NOV., 2	2022		HORIZ. SCALE (FULL): N/A	CLIENT:	THE COMMONS CLUB AT THE BROOKS, INC.
Fort Myers, Florida 33907 (239) 597-0575 FAX: (239) 597-0578	sec: 10	twp: 47S	rge: 25E	horiz. scale (half): N/A		
www.consult-rwa.com Florida Certificates of Authorization	designed: MC	CP		vert. scale (full): N/A	TITLE:	
EB 7663 LB6952	drawn: HG	īD		vert. scale (half): N/A		GENERAL NOTES

	RWISE SHOWN, ABBREVI <i>)</i> L <b>ITIES</b>	ATIONS AND STRIBUL			,
(EXIST)	(PROP)		UTILITI	IES (CONTINU	ED)
()	■ = BACKFLOW PRE	VENTER	74777	= 11.25° TO 90° BEN	ND
$\mathbb{W}/\mathbb{N}$	= GATE VALVE		n	= TEE	
$\triangleleft$	REDUCER		0	= CROSS	
	= WATER SERVICE	(SINGLE)	Ύι Ν	= WYE = CHECK VALVE	
-6 <b>-</b>	= WATER SERVICE	(DOUBLE)	N		
¥/ <del>}0</del> +	= FIRE HYDRANT A	ASSEMBLY	•		
· -	♂ = FIRE DEPARTME		8	= AIR RELEASE VAL	VE
	= FORCE MAIN VA		MISCELI	LANEOUS	
	= PLUG VALVE			= PARKING COUNT	
3/0	SANITARY MAN	HOLE	(5) 9		
	= CLEAN-OUT (SIN	NGLE)	$\otimes$	= NATIVE PRESERVE	SIGN
	= CLEAN-OUT (DC			= LIGHT POLE	
$\sim$	= STORM INLET/JU	,	K.	= EXISTING POWER	POLE
	= STORM FLARED		<b>X</b>	= POWER POLE	
	= STORM DRAIN N		⊶€	= POWER POLE WIT	'H LIGHT
0/0			←	= GUY WIRE	
	= MITERED END SI	ECTION	<b>⊕</b> ☆	= BOLLARD	
	FLUME WITH RIF	P RAP	× <sup>22.0</sup>	= EXISTING GRADE	TEXT
	= DRAINAGE FLOV	N ARROW	XX.XX	= PROPOSED GRAD	E TEXT
$\sim$	(ALWAYS POINTS			= CURB RAMP TYPE	PER FDOT
			(CR-X)	INDEX 522-002, FY	2020-21
			後	= OAK TREE WITH D	DIAMETER
			*	= PALM TREE WITH	DIAMETER
STANDA	RD LINES:	<ul> <li>OTHERWISE SHOWN</li> <li>= PROJECT BOUND.</li> </ul>			
	RD LINES:	<ul> <li>= PROJECT BOUND.</li> </ul>			RD HATCHES
	<u>ARD LINES:</u>	<ul> <li>= PROJECT BOUND.</li> <li>= R/W LINE</li> </ul>			= PAVEMENT
	<u>RD LINES:</u>	<ul> <li>= PROJECT BOUND.</li> <li>= R/W LINE</li> <li>= EASEMENT</li> </ul>			
	ARD LINES:	<ul> <li>= PROJECT BOUND.</li> <li>= R/W LINE</li> <li>= EASEMENT</li> <li>= CENTERLINE</li> </ul>			= PAVEMENT = CONCRETE
	ARD LINES:	<ul> <li>= PROJECT BOUND.</li> <li>= R/W LINE</li> <li>= EASEMENT</li> <li>= CENTERLINE</li> <li>= SET-BACK LINE</li> </ul>	ARY LINE		= PAVEMENT
	ARD LINES:	<ul> <li>= PROJECT BOUND.</li> <li>= R/W LINE</li> <li>= EASEMENT</li> <li>= CENTERLINE</li> </ul>	ARY LINE		= PAVEMENT = CONCRETE = BRICK PAVER
	ARD LINES:	<ul> <li>= PROJECT BOUND.</li> <li>= R/W LINE</li> <li>= EASEMENT</li> <li>= CENTERLINE</li> <li>= SET-BACK LINE</li> </ul>	ARY LINE OF BANK		= PAVEMENT = CONCRETE
	ARD LINES:	<ul> <li>= PROJECT BOUND.</li> <li>= R/W LINE</li> <li>= EASEMENT</li> <li>= CENTERLINE</li> <li>= SET-BACK LINE</li> <li>= DETENTION TOP</li> </ul>	ARY LINE OF BANK OF SLOPE		= PAVEMENT = CONCRETE = BRICK PAVER = RIPRAP/GRAVEL
	<u>ARD LINES:</u>	<ul> <li>= PROJECT BOUND.</li> <li>= R/W LINE</li> <li>= EASEMENT</li> <li>= CENTERLINE</li> <li>= SET-BACK LINE</li> <li>= DETENTION TOP</li> <li>= DETENTION TOE</li> </ul>	ARY LINE OF BANK OF SLOPE IE		= PAVEMENT = CONCRETE = BRICK PAVER
	ARD LINES:	<ul> <li>= PROJECT BOUND.</li> <li>= R/W LINE</li> <li>= EASEMENT</li> <li>= CENTERLINE</li> <li>= SET-BACK LINE</li> <li>= DETENTION TOP</li> <li>= DETENTION TOP</li> <li>= MAJOR BASIN LIN</li> </ul>	ARY LINE OF BANK OF SLOPE NE		<ul> <li>PAVEMENT</li> <li>CONCRETE</li> <li>BRICK PAVER</li> <li>RIPRAP/GRAVEL</li> <li>COMPACTED</li> </ul>
	<b>RD LINES:</b>	<ul> <li>PROJECT BOUND.</li> <li>R/W LINE</li> <li>EASEMENT</li> <li>CENTERLINE</li> <li>SET-BACK LINE</li> <li>DETENTION TOP</li> <li>DETENTION TOP</li> <li>MAJOR BASIN LIN</li> <li>IRRIGATION (PRO</li> </ul>	ARY LINE OF BANK OF SLOPE NE NE POSED)		= PAVEMENT = CONCRETE = BRICK PAVER = RIPRAP/GRAVEL
		<ul> <li>= PROJECT BOUNDATE</li> <li>= R/W LINE</li> <li>= EASEMENT</li> <li>= CENTERLINE</li> <li>= SET-BACK LINE</li> <li>= DETENTION TOP</li> <li>= DETENTION TOP</li> <li>= MAJOR BASIN LIN</li> <li>= MINOR BASIN LIN</li> <li>= IRRIGATION (PRO</li> <li>= IRRIGATION (EXIS)</li> </ul>	ARY LINE OF BANK OF SLOPE JE JE JPOSED) TING)		<ul> <li>PAVEMENT</li> <li>CONCRETE</li> <li>BRICK PAVER</li> <li>RIPRAP/GRAVEL</li> <li>COMPACTED</li> <li>EARTH</li> </ul>
		<ul> <li>PROJECT BOUND.</li> <li>R/W LINE</li> <li>EASEMENT</li> <li>CENTERLINE</li> <li>SET-BACK LINE</li> <li>DETENTION TOP</li> <li>DETENTION TOP</li> <li>MAJOR BASIN LIN</li> <li>IRRIGATION (PRO</li> <li>IRRIGATION (EXIS</li> <li>SEWER FORCE MA</li> </ul>	ARY LINE OF BANK OF SLOPE NE NE POSED) ITING) AIN (PROP)		<ul> <li>PAVEMENT</li> <li>CONCRETE</li> <li>BRICK PAVER</li> <li>RIPRAP/GRAVEL</li> <li>COMPACTED</li> </ul>
	ARD LINES:	<ul> <li>= PROJECT BOUND.</li> <li>= R/W LINE</li> <li>= EASEMENT</li> <li>= CENTERLINE</li> <li>= SET-BACK LINE</li> <li>= DETENTION TOP</li> <li>= DETENTION TOP</li> <li>= MAJOR BASIN LIN</li> <li>= IRRIGATION (PRO</li> <li>= IRRIGATION (EXIS</li> <li>= SEWER FORCE MA</li> </ul>	ARY LINE OF BANK OF SLOPE JE JE JPOSED) ITING) AIN (PROP) AIN (EXIST)		<ul> <li>PAVEMENT</li> <li>CONCRETE</li> <li>BRICK PAVER</li> <li>RIPRAP/GRAVEL</li> <li>COMPACTED</li> <li>EARTH</li> <li>LAKE</li> <li>LITTORAL AREA</li> </ul>
		<ul> <li>= PROJECT BOUND.</li> <li>= R/W LINE</li> <li>= EASEMENT</li> <li>= CENTERLINE</li> <li>= SET-BACK LINE</li> <li>= DETENTION TOP</li> <li>= DETENTION TOP</li> <li>= MAJOR BASIN LIN</li> <li>= IRRIGATION (PRO</li> <li>= IRRIGATION (EXIS</li> <li>= SEWER FORCE MA</li> </ul>	ARY LINE OF BANK OF SLOPE JE JE JPOSED) ITING) AIN (PROP) AIN (EXIST)		<ul> <li>PAVEMENT</li> <li>CONCRETE</li> <li>BRICK PAVER</li> <li>RIPRAP/GRAVEL</li> <li>COMPACTED</li> <li>EARTH</li> <li>LAKE</li> <li>LITTORAL AREA</li> </ul>
	ARD LINES:	<ul> <li>PROJECT BOUND.</li> <li>R/W LINE</li> <li>EASEMENT</li> <li>CENTERLINE</li> <li>SET-BACK LINE</li> <li>DETENTION TOP</li> <li>DETENTION TOE</li> <li>MAJOR BASIN LIN</li> <li>IRRIGATION (PRO</li> <li>IRRIGATION (EXIS</li> <li>SEWER FORCE MA</li> <li>SANITARY SEWER</li> </ul>	ARY LINE OF BANK OF SLOPE NE PPOSED) ITING) AIN (PROP) AIN (EXIST) & (PROP)		<ul> <li>PAVEMENT</li> <li>CONCRETE</li> <li>BRICK PAVER</li> <li>RIPRAP/GRAVEL</li> <li>COMPACTED</li> <li>EARTH</li> <li>LAKE</li> <li>LITTORAL AREA (OVER LAKE HTCH)</li> <li>SAFE SIGHT</li> </ul>
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	Image: Second state sta	<ul> <li>PROJECT BOUND.</li> <li>R/W LINE</li> <li>EASEMENT</li> <li>CENTERLINE</li> <li>SET-BACK LINE</li> <li>DETENTION TOP</li> <li>DETENTION TOP</li> <li>MAJOR BASIN LIN</li> <li>MINOR BASIN LIN</li> <li>IRRIGATION (PRO</li> <li>IRRIGATION (EXIS</li> <li>SEWER FORCE MA</li> <li>SEWER FORCE MA</li> <li>SANITARY SEWER</li> <li>STORM DRAIN (P</li> </ul>	ARY LINE OF BANK OF SLOPE JE PPOSED) TING) AIN (PROP) AIN (EXIST) & (PROP) & (EXIST) ROP)		<ul> <li>PAVEMENT</li> <li>CONCRETE</li> <li>BRICK PAVER</li> <li>RIPRAP/GRAVEL</li> <li>COMPACTED</li> <li>EARTH</li> <li>LAKE</li> <li>LITTORAL AREA (OVER LAKE HTCH</li> <li>SAFE SIGHT DISTANCE</li> </ul>
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	Image: Second	<ul> <li>PROJECT BOUND.</li> <li>R/W LINE</li> <li>EASEMENT</li> <li>CENTERLINE</li> <li>SET-BACK LINE</li> <li>DETENTION TOP</li> <li>DETENTION TOP</li> <li>MAJOR BASIN LIN</li> <li>MINOR BASIN LIN</li> <li>IRRIGATION (PRO</li> <li>IRRIGATION (EXIS</li> <li>SEWER FORCE MA</li> <li>SEWER FORCE MA</li> <li>SANITARY SEWER</li> <li>STORM DRAIN (PRO</li> <li>STORM DRAIN (PRO</li> <li>WATER MAIN (PRO</li> </ul>	ARY LINE OF BANK OF SLOPE JE PPOSED) TTING) AIN (PROP) AIN (EXIST) & (PROP) & (EXIST) ROP) XIST) OP)		<ul> <li>PAVEMENT</li> <li>CONCRETE</li> <li>BRICK PAVER</li> <li>RIPRAP/GRAVEL</li> <li>COMPACTED</li> <li>EARTH</li> <li>LAKE</li> <li>LITTORAL AREA (OVER LAKE HTCH)</li> <li>SAFE SIGHT DISTANCE</li> </ul>
I	<b>RD LINES:</b>	<ul> <li>PROJECT BOUNDATE</li> <li>R/W LINE</li> <li>EASEMENT</li> <li>CENTERLINE</li> <li>SET-BACK LINE</li> <li>DETENTION TOP IN</li> <li>DETENTION TOP IN</li> <li>MAJOR BASIN LIN</li> <li>MINOR BASIN LIN</li> <li>IRRIGATION (PRO</li> <li>IRRIGATION (PRO</li> <li>SEWER FORCE MA</li> <li>SEWER FORCE MA</li> <li>SEWER FORCE MA</li> <li>SANITARY SEWER</li> <li>STORM DRAIN (PRO</li> <li>WATER MAIN (PRO</li> <li>WATER MAIN (PA</li> </ul>	ARY LINE OF BANK OF SLOPE JE PPOSED) TTING) AIN (PROP) AIN (EXIST) & (PROP) & (EXIST) ROP) XIST) OP)		<ul> <li>PAVEMENT</li> <li>CONCRETE</li> <li>BRICK PAVER</li> <li>RIPRAP/GRAVEL</li> <li>COMPACTED</li> <li>EARTH</li> <li>LAKE</li> <li>LITTORAL AREA (OVER LAKE HTCH</li> <li>SAFE SIGHT DISTANCE</li> </ul>
	Image: Second	<ul> <li>PROJECT BOUND.</li> <li>R/W LINE</li> <li>EASEMENT</li> <li>CENTERLINE</li> <li>SET-BACK LINE</li> <li>DETENTION TOP</li> <li>DETENTION TOP</li> <li>MAJOR BASIN LIN</li> <li>MINOR BASIN LIN</li> <li>IRRIGATION (PRO</li> <li>IRRIGATION (EXIS</li> <li>SEWER FORCE MA</li> <li>SEWER FORCE MA</li> <li>SANITARY SEWER</li> <li>SANITARY SEWER</li> <li>STORM DRAIN (PR</li> <li>WATER MAIN (PR</li> <li>WATER MAIN (PR</li> <li>WATER MAIN (PR</li> <li>FIRE LINE (PROP)</li> </ul>	ARY LINE OF BANK OF SLOPE JE PPOSED) TTING) AIN (PROP) AIN (EXIST) & (PROP) & (EXIST) ROP) XIST) OP)		<ul> <li>PAVEMENT</li> <li>CONCRETE</li> <li>BRICK PAVER</li> <li>RIPRAP/GRAVEL</li> <li>COMPACTED</li> <li>EARTH</li> <li>LAKE</li> <li>LITTORAL AREA (OVER LAKE HTCH</li> <li>SAFE SIGHT DISTANCE</li> </ul>
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I         I-X         F         F-X         S-X         D-X         W-X         F         F         F         F         F         F         F-X         F         F         F         F         F         OH	<b>RD LINES:</b>	<ul> <li>PROJECT BOUNDATE</li> <li>R/W LINE</li> <li>EASEMENT</li> <li>CENTERLINE</li> <li>SET-BACK LINE</li> <li>DETENTION TOP</li> <li>DETENTION TOP</li> <li>MAJOR BASIN LIN</li> <li>MINOR BASIN LIN</li> <li>IRRIGATION (PRO</li> <li>IRRIGATION (PRO</li> <li>SEWER FORCE MA</li> <li>SEWER FORCE MA</li> <li>SEWER FORCE MA</li> <li>SEWER FORCE MA</li> <li>SANITARY SEWER</li> <li>SANITARY SEWER</li> <li>STORM DRAIN (PR</li> <li>WATER MAIN (PR</li> <li>WATER MAIN (PR</li> <li>WATER MAIN (EX</li> <li>FIRE LINE (PROP)</li> <li>FIRE LINE (EXIST)</li> <li>OVERHEAD ELECT</li> </ul>	ARY LINE OF BANK OF SLOPE NE POSED) TING) AIN (PROP) AIN (EXIST) (PROP) (EXIST) ROP) XIST) OP) IST)		<ul> <li>PAVEMENT</li> <li>CONCRETE</li> <li>BRICK PAVER</li> <li>RIPRAP/GRAVEL</li> <li>COMPACTED</li> <li>EARTH</li> <li>LAKE</li> <li>LITTORAL AREA (OVER LAKE HTCH)</li> <li>SAFE SIGHT DISTANCE</li> </ul>
I         I-X         F         F-X         S-X         D-X         W-X         W-X         FL-X         OH         G	Image: Second	<ul> <li>PROJECT BOUNDATE</li> <li>R/W LINE</li> <li>EASEMENT</li> <li>CENTERLINE</li> <li>SET-BACK LINE</li> <li>DETENTION TOP</li> <li>DETENTION TOP</li> <li>MAJOR BASIN LIN</li> <li>MINOR BASIN LIN</li> <li>IRRIGATION (PRO)</li> <li>IRRIGATION (EXIS)</li> <li>SEWER FORCE MAATION (EXIS)</li> <li>SEWER FORCE MAATION (EXIS)</li> <li>SEWER FORCE MAATION (EXIS)</li> <li>SANITARY SEWER</li> <li>SANITARY SEWER</li> <li>STORM DRAIN (PRO)</li> <li>STORM DRAIN (PRO)</li> <li>FIRE LINE (PROP)</li> <li>FIRE LINE (EXIST)</li> <li>OVERHEAD ELECT</li> <li>NATURAL GAS (PRO)</li> </ul>	ARY LINE OF BANK OF SLOPE JE JE PPOSED) TING) AIN (PROP) AIN (EXIST) AIN (EXIST) CP) S (EXIST) OP) IST)		<ul> <li>PAVEMENT</li> <li>CONCRETE</li> <li>BRICK PAVER</li> <li>RIPRAP/GRAVEL</li> <li>COMPACTED</li> <li>EARTH</li> <li>LAKE</li> <li>LITTORAL AREA (OVER LAKE HTCH)</li> <li>SAFE SIGHT DISTANCE</li> </ul>
I         I         I-X         F         F-X         S-X         S-X         D-X         W-X         F         G         G-X	Image: Second	<ul> <li>PROJECT BOUNDATE</li> <li>R/W LINE</li> <li>EASEMENT</li> <li>CENTERLINE</li> <li>SET-BACK LINE</li> <li>DETENTION TOP</li> <li>DETENTION TOP</li> <li>MAJOR BASIN LIN</li> <li>MINOR BASIN LIN</li> <li>IRRIGATION (PRO)</li> <li>IRRIGATION (EXIS)</li> <li>SEWER FORCE MAATION (EXIS)</li> <li>SEWER FORCE MAATION (EXIS)</li> <li>SEWER FORCE MAATION (EXIS)</li> <li>SANITARY SEWER</li> <li>SANITARY SEWER</li> <li>STORM DRAIN (PRO)</li> <li>STORM DRAIN (PRO)</li> <li>FIRE LINE (PROP)</li> <li>FIRE LINE (EXIST)</li> <li>OVERHEAD ELECT</li> <li>NATURAL GAS (PRO)</li> </ul>	ARY LINE OF BANK OF SLOPE IE POSED) TING) AIN (PROP) AIN (EXIST) (PROP) (EXIST) ROP) XIST) OP) IST)		<ul> <li>PAVEMENT</li> <li>CONCRETE</li> <li>BRICK PAVER</li> <li>RIPRAP/GRAVEL</li> <li>COMPACTED</li> <li>EARTH</li> <li>LAKE</li> <li>LITTORAL AREA (OVER LAKE HTCH)</li> <li>SAFE SIGHT DISTANCE</li> </ul>
	Image: Second	<ul> <li>PROJECT BOUNDATE</li> <li>R/W LINE</li> <li>EASEMENT</li> <li>CENTERLINE</li> <li>SET-BACK LINE</li> <li>DETENTION TOP</li> <li>DETENTION TOP</li> <li>MAJOR BASIN LIN</li> <li>MINOR BASIN LIN</li> <li>IRRIGATION (PRO</li> <li>IRRIGATION (EXIS)</li> <li>SEWER FORCE MAATION</li> <li>SANITARY SEWER</li> <li>SANITARY SEWER</li> <li>STORM DRAIN (PRO</li> <li>FIRE LINE (PROP)</li> <li>FIRE LINE (EXIST)</li> <li>OVERHEAD ELECT</li> <li>NATURAL GAS (PI</li> <li>TURBIDITY BARRII</li> </ul>	ARY LINE OF BANK OF SLOPE IE POSED) TING) AIN (PROP) AIN (EXIST) (PROP) (EXIST) ROP) XIST) OP) IST)		<ul> <li>PAVEMENT</li> <li>CONCRETE</li> <li>BRICK PAVER</li> <li>RIPRAP/GRAVEL</li> <li>COMPACTED</li> <li>EARTH</li> <li>LAKE</li> <li>LITTORAL AREA (OVER LAKE HTCH)</li> <li>SAFE SIGHT DISTANCE</li> </ul>
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THE COI	MMONS CLUB AT THE BROO EBALL FACILITY EXPANSION	)	
PROJECT NO.:	FILE NAME:	sheet number:	MICHAEL C. PAPPAS
220002.00.02	02 2200020100C GN01	02 of 8	FLORIDA LICENSE NO. 60910

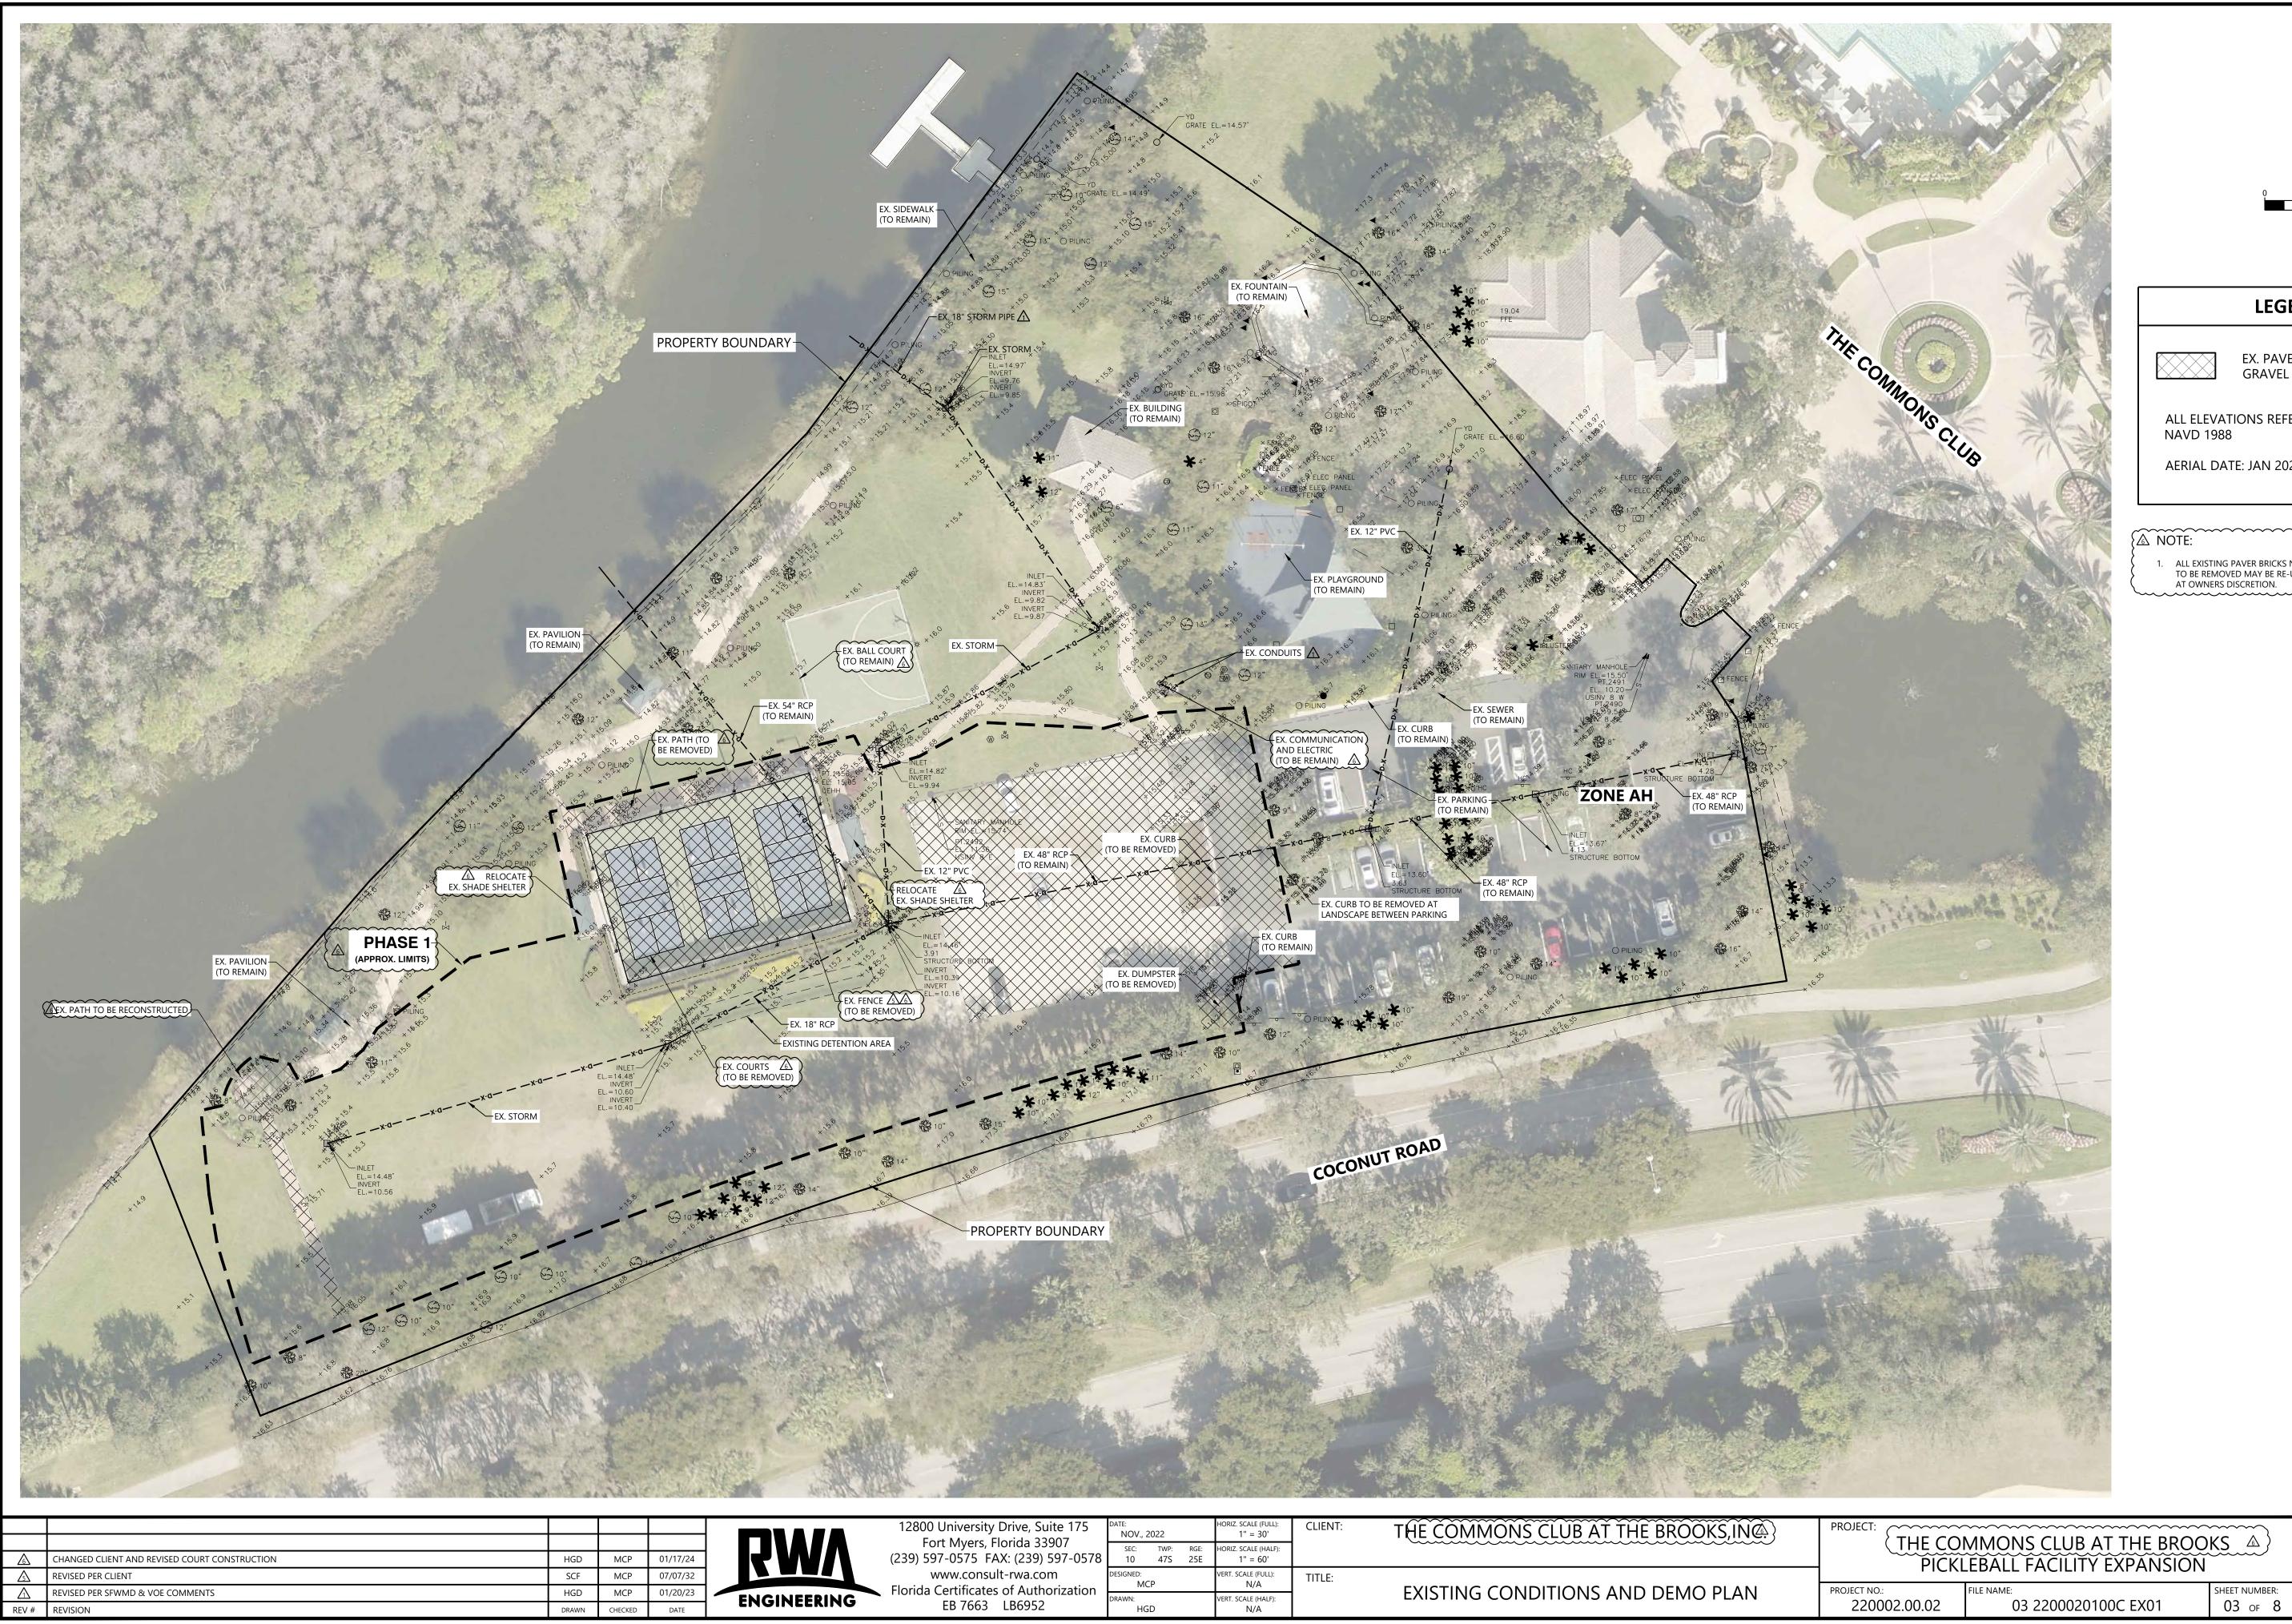

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12800 University Drive, Suite 175 Fort Myers, Florida 33907	date: NOV., 2022	HORIZ. SCALE (FULL): 1" = 30'	CLIENT: T	HE COMMONS CLUB AT THE BROOKS, INC.
(239) 597-0575 FAX: (239) 597-0578		HORIZ. SCALE (HALF): 1" = 60'		
www.consult-rwa.com Florida Certificates of Authorization	designed: MCP	vert. scale (full): N/A	TITLE:	EXISTING CONDITIONS AND DEMO PLAN
EB 7663 LB6952	drawn: HGD	vert. scale (half): N/A		EXISTING CONDITIONS AND DEIVIO PLAN

0	30	60
		Feet

#### LEGEND


## EX. PAVEMENT/CONCRETE/ GRAVEL TO BE REMOVED

ALL ELEVATIONS REFERENCE

AERIAL DATE: JAN 2022

{ NOTE: 1. ALL EXISTING PAVER BRICKS NOTED TO BE REMOVED MAY BE RE-USED AT OWNERS DISCRETION.

MICHAEL C. PAPP	AS
ORIDA LICENSE NO.	60910

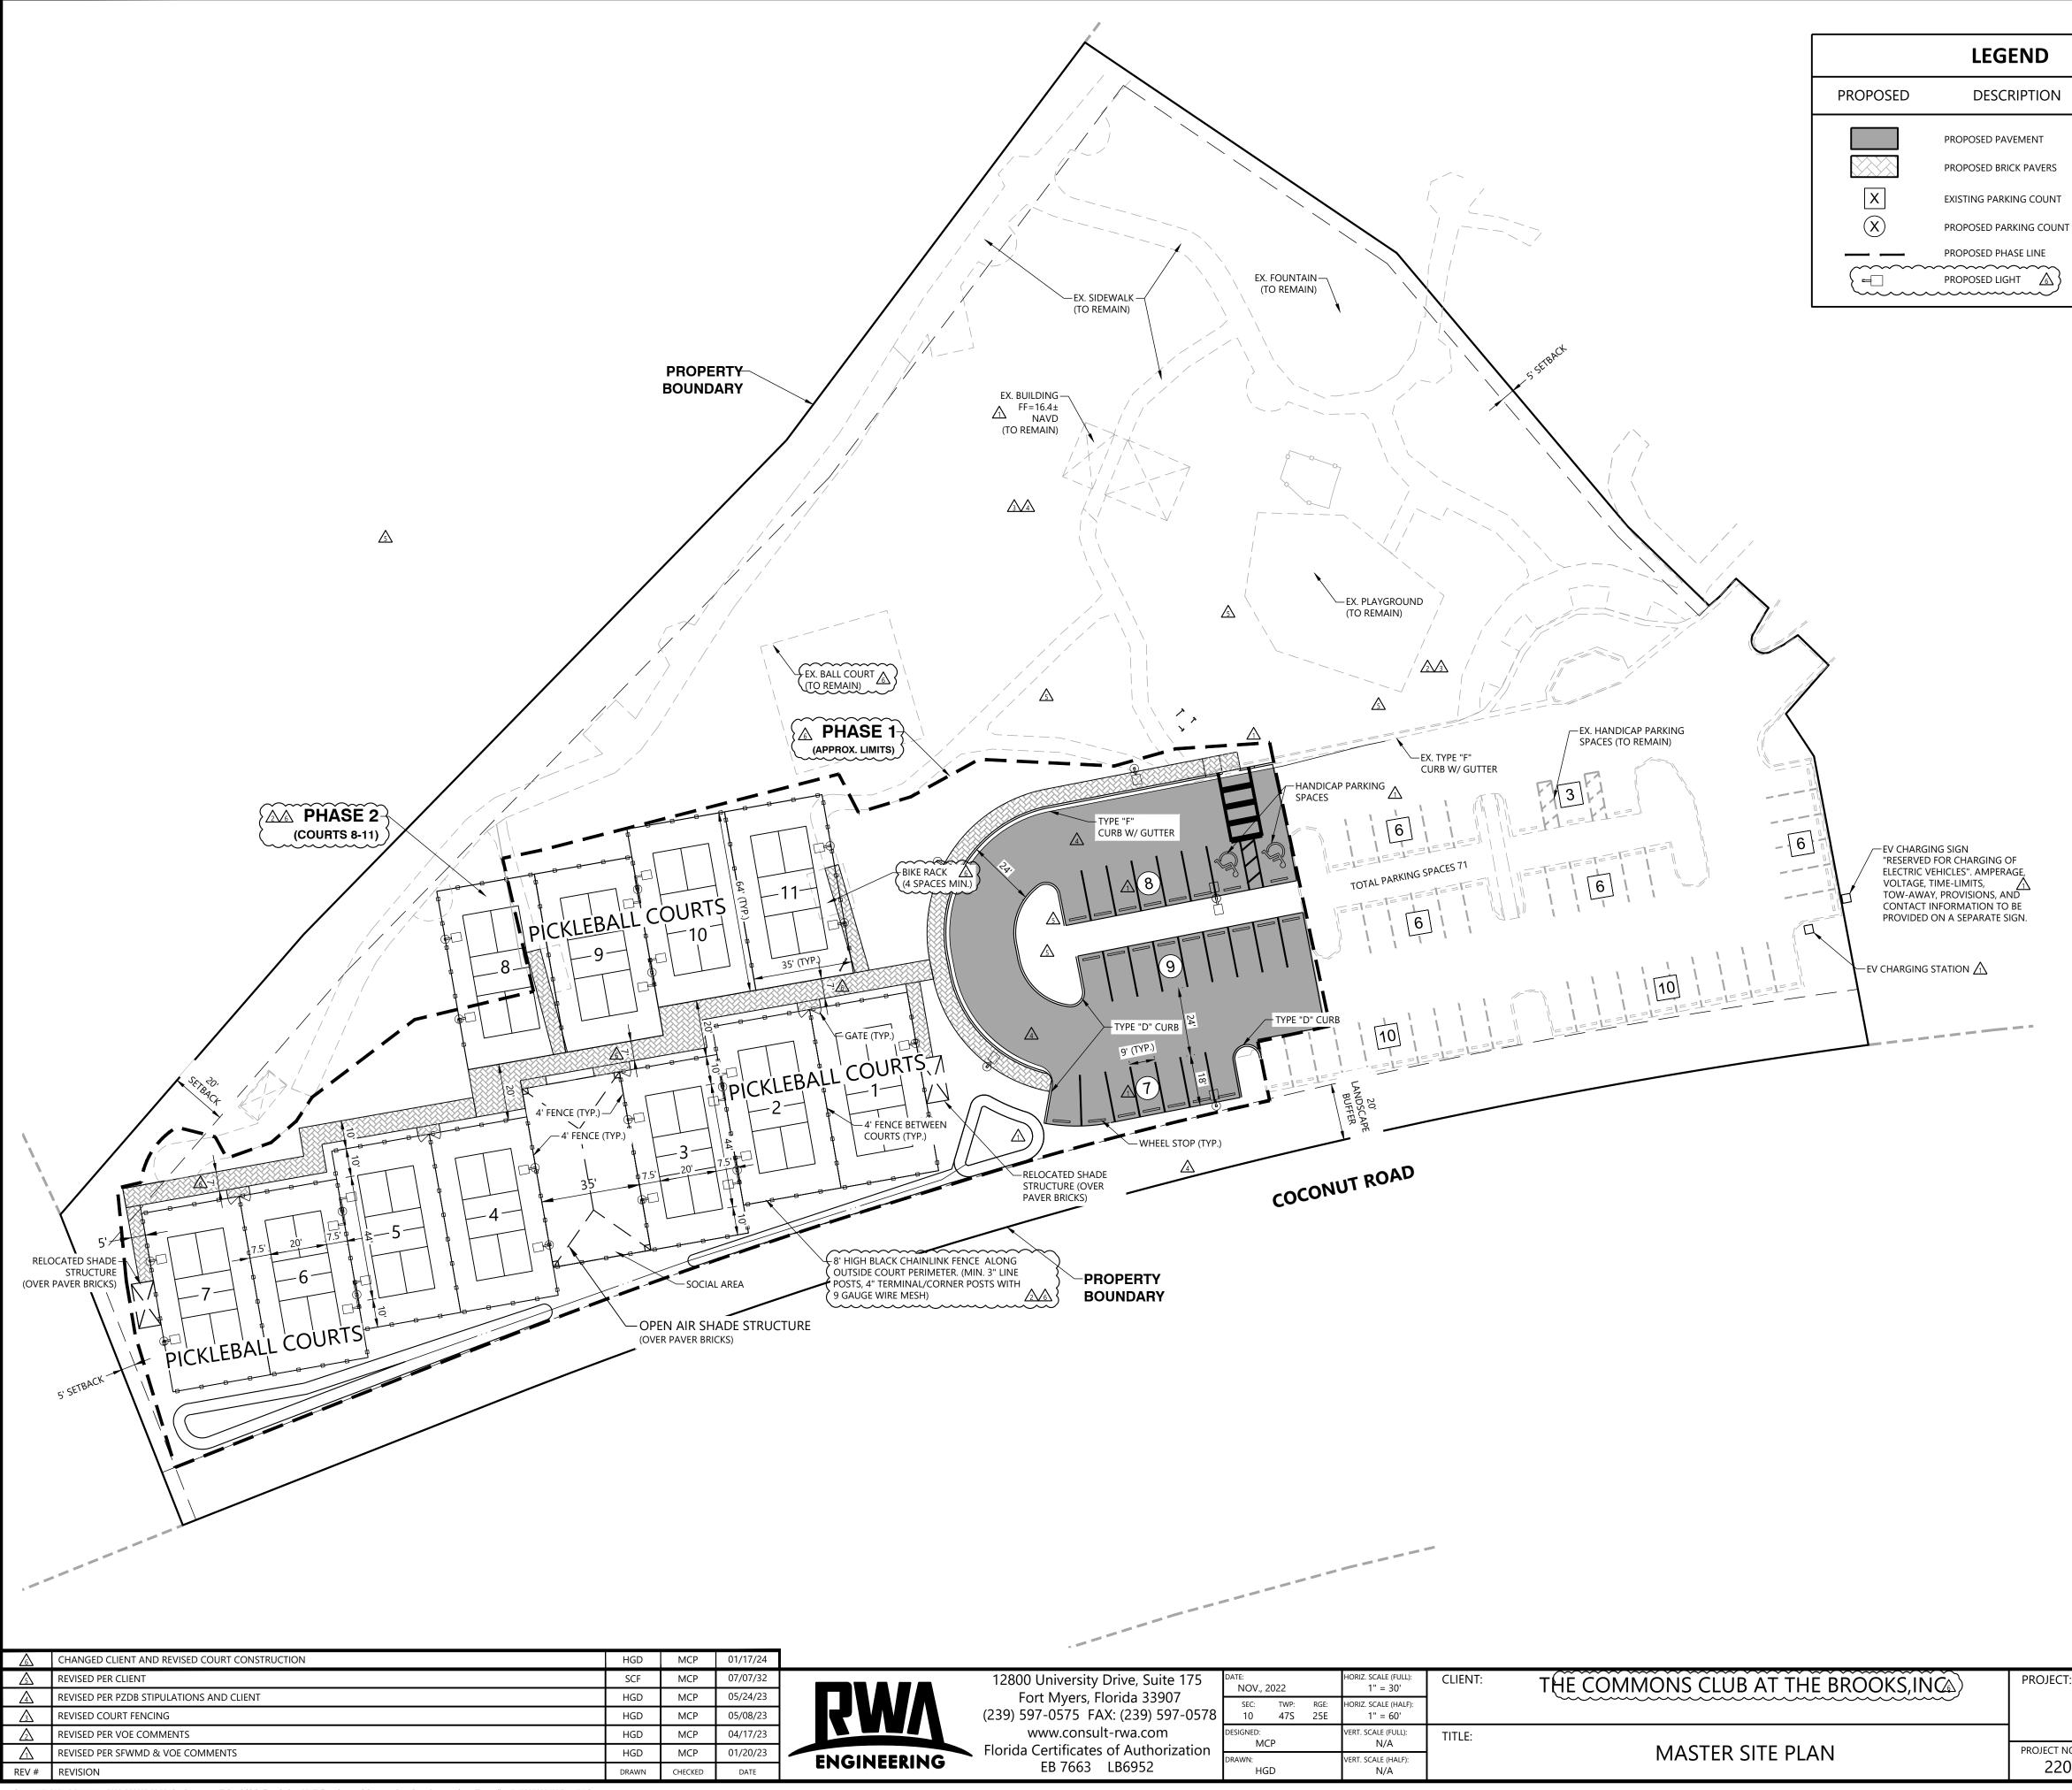


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#### LEGEND

DESCRIPTION

EXISTING PARKING COUNT

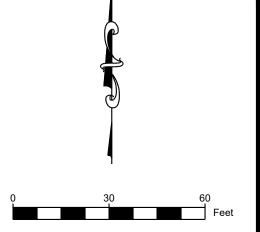

EXISTING PARKING CALCULATIONS								
USE	INTENSITY	RATIO	REQUIRED					
RESTAURANT	10,494 SF *	12.5 / 1,000 SF	131					
OUTDOOR SEATING	1,687 SF *	12.5 / 1,000 SF	21					
HEALTH CLUB	16,648 SF *	5 / 1,000 SF	83					
ENRICHMENT CENTER	4,863 SF *	3.5 / 1,000 SF	17					
OFFICE	40,000 SF *	1 / 350 SF	114					
SPORTS COURTS	3.5 *	3 /COURT	11					
REQUIRED	ŀ	DTAL SPACES 377 HANDICAP SPACE 8 ICYCLE 19						
	ТС	DTAL SPACE 390 ANDARD SPACES 370						
PROVIDED		ANDICAP SPACE 20 BICYCLE 28						
PARKING CALCU	LATIONS FROM AGNOLI	BARBER & BRUNDAG	E, INC., PLANS 2019					

PROPOSED PARKING CALCULATIONS								
USE	INTENSITY	REQUIRED						
RESTAURANT	10,494 SF *	12.5 / 1,000 SF	131					
OUTDOOR SEATING	1,687 SF * 12.5 / 1,000 SF 21							
HEALTH CLUB	16,648 SF * 5 / 1,000 SF 83							
ENRICHMENT CENTER	4,863 SF * 3.5 / 1,000 SF 17							
OFFICE	40,000 SF *	1 / 350 SF	114					
SPORTS COURTS		3 /COURT	33					
	Т	OTAL SPACES 399 6	$\langle \rangle$					
REQUIRED	HANDICAP SPACE 9							
	BICYCLE 19							
	٦	TOTAL SPACES 414						
	STANDARD SPACES 392 $\Lambda$							
PROVIDED	Н	HANDICAP SPACE 22						
	В	ICYCLE 19						

PARKING CALCULATIONS FROM AGNOLI BARBER & BRUNDAGE, INC., PLANS 2019

LAND USE SUMMARY							
COVERAGE	EXISTING (AC)	PROPOSED (AC)					
BUILDING	0.02	0.02					
PERVIOUS AREA	2.46	1.63 🕂					
IMPERVIOUS AREA	1.25	2.08 🚹					
TOTAL AREA	3.73	3.73					


WATER MANAGEMENT SUMMARY * 🛆							
BASIN 2B	ELEVATION						
CONTROL ELEVATION	13.60 NGVD29/12.39 NAVD88						
5 YEAR 1 DAY PEAK STAGE	14.85 NGVD29/13.64 NAVD88						
MIN. PROP ROAD CROWN	15.6 NGVD29/14.39 NAVD88						
100 YEAR 3 DAY PEAK STAGE	16.61 NGVD29/15.40 NAVD88						
MIN. PROP FINISHED FLOOR	17.1 NGVD29/15.89 NAVD88						

\* INFORMATION FROM APP. NO. 970710-1 🔬

PHASING PLAN						
PHASE	DESCRIPTION					
1	REMOVE EXISTING COURTS, DEVELOP COURTS 1-7, SIDEWALK, OPEN AIR STRUCTURE NEAR COURTS, AND PARKING.					
2	DEVELOP COURTS 8-11					


OPEN SPACE REQUIRED = 30% OPEN SPACE PROVIDED = 44%

PROJECT: THE COI PICKL	MMONS CLUB AT THE BROO EBALL FACILITY EXPANSION	KS A	
PROJECT NO.:	FILE NAME:	sheet number:	MICHAEL C. PAPPAS
220002.00.02	04 2200020100C MP01	04 of 8	FLORIDA LICENSE NO. 60910

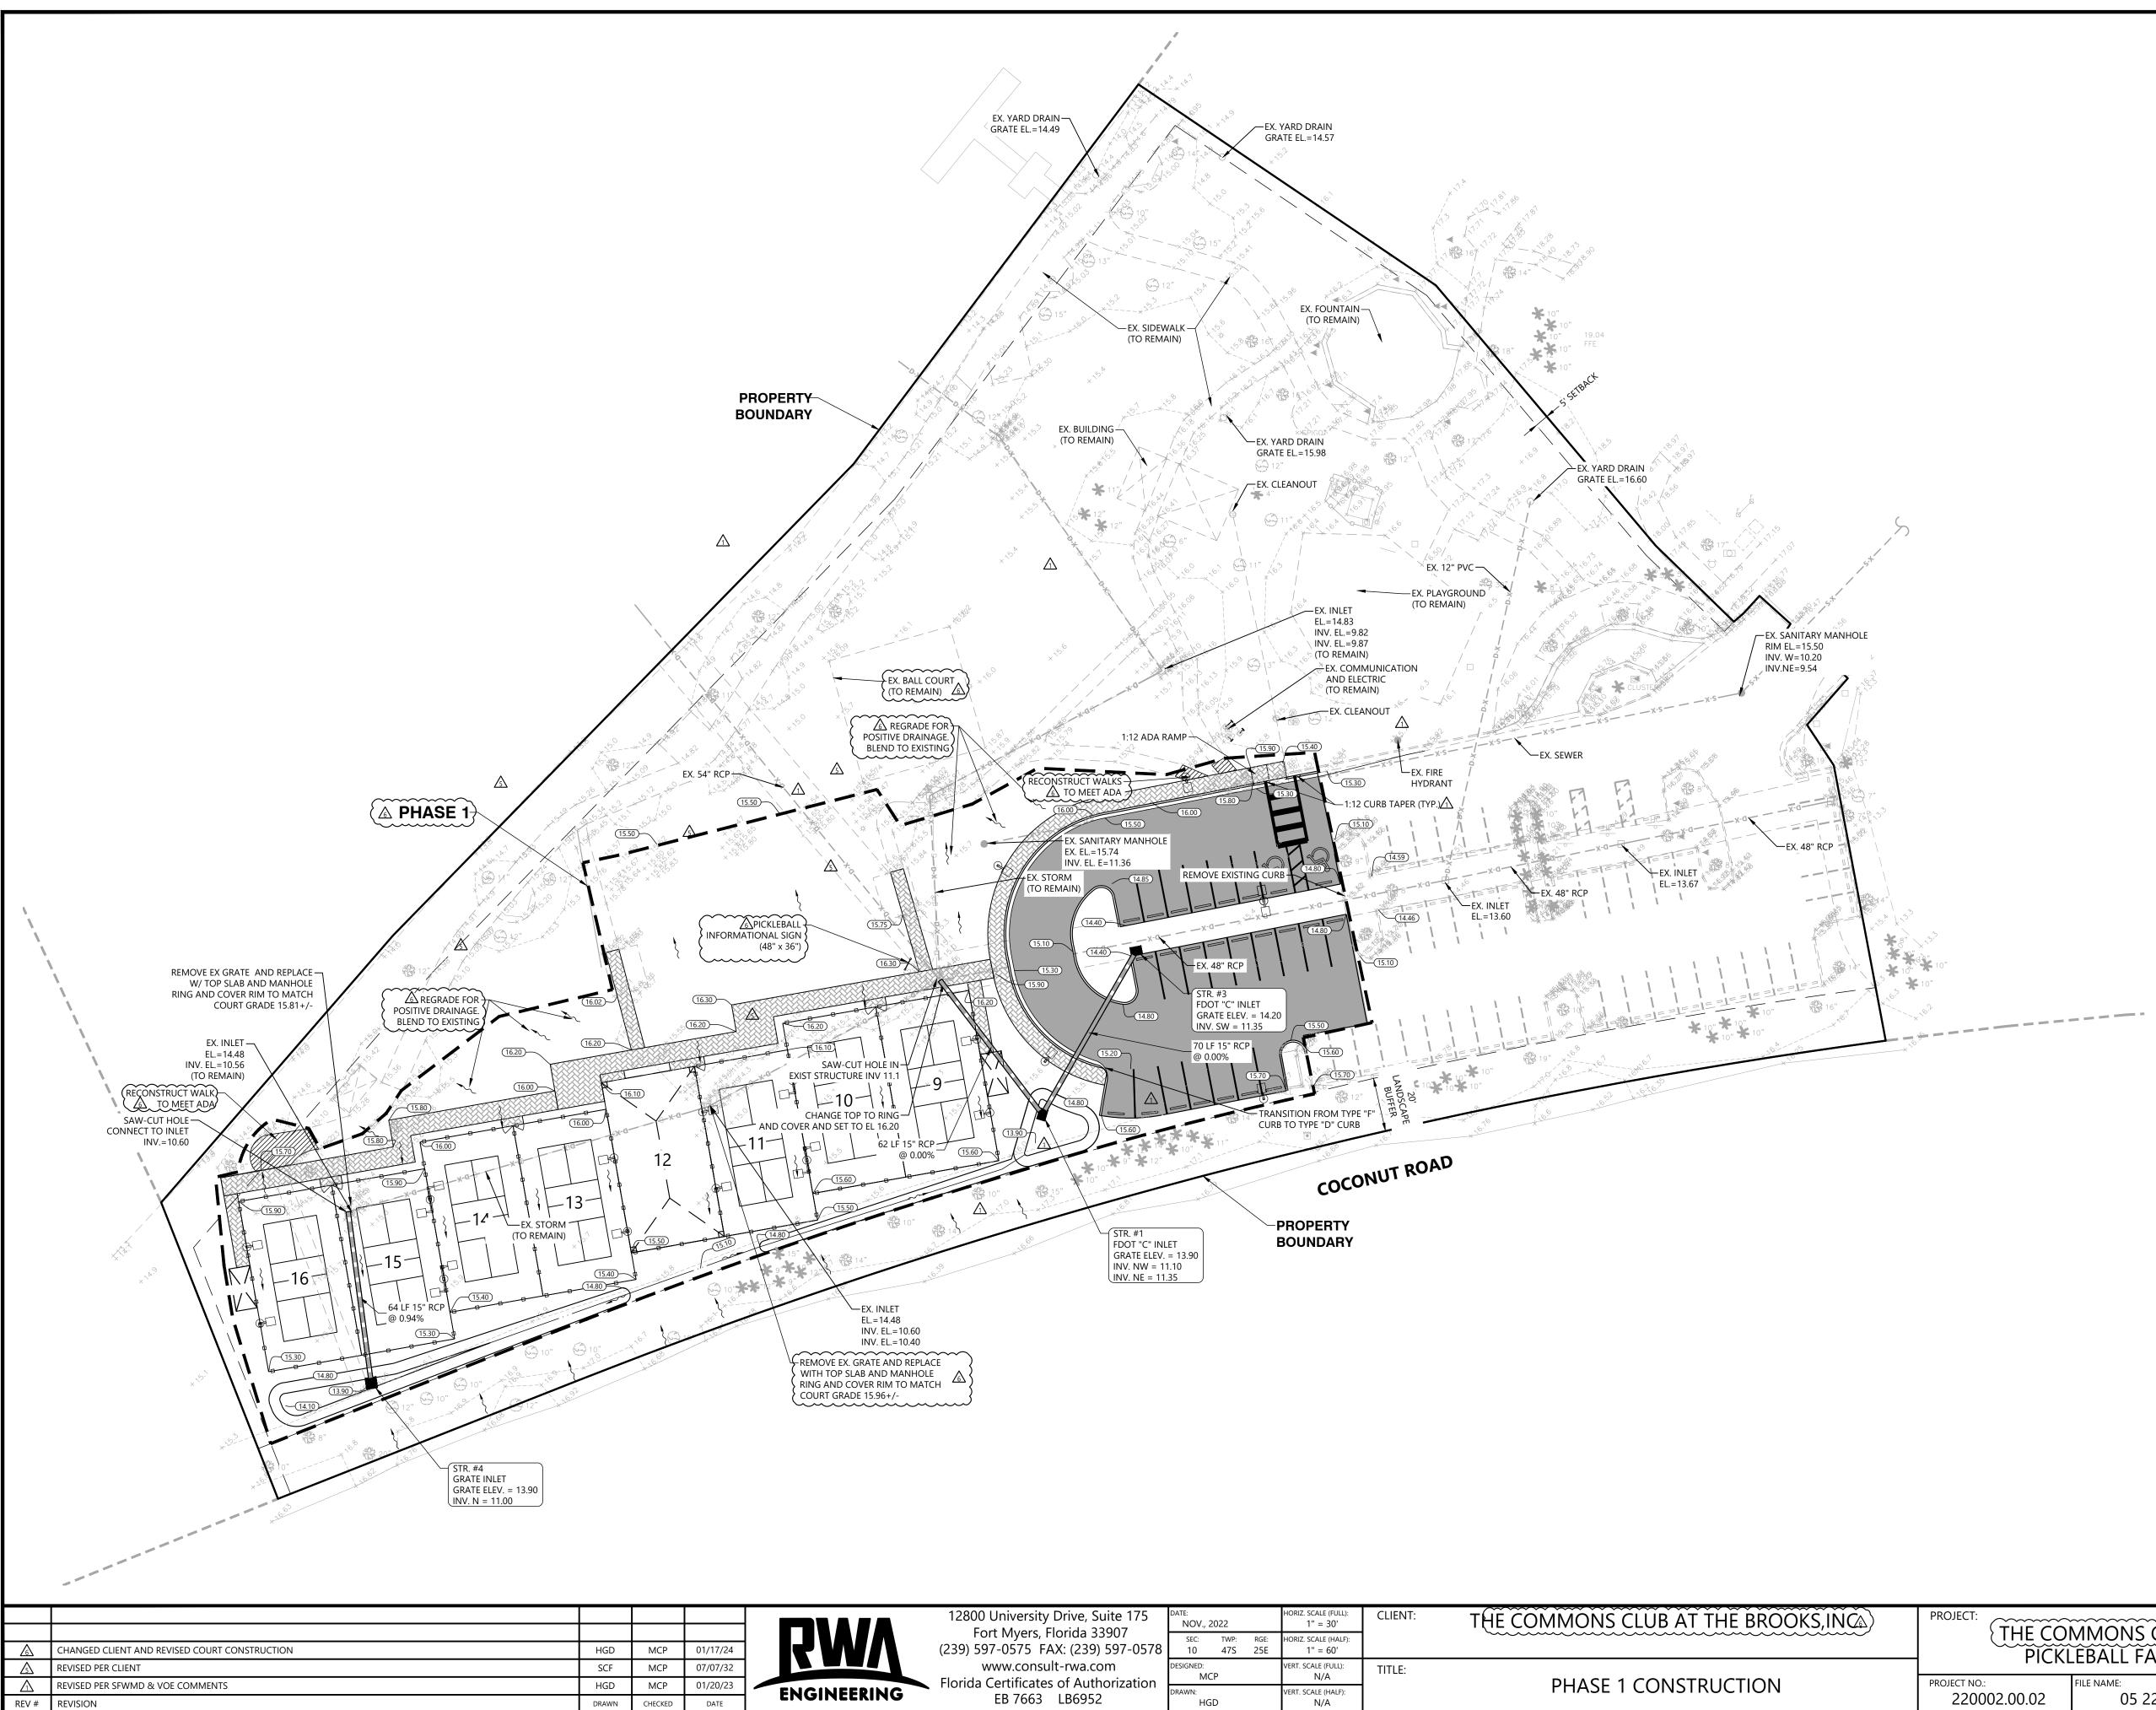


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	12800 University Drive, Suite 175	date: NOV., 2022	HORIZ. SCALE (FULL): 1" = 30'	CLIENT:	THE COMMONS CLUB AT THE BROOKS, INCA	· · · · · · · · · · · · · · · · · · ·			
	Fort Myers, Florida 33907 (239) 597-0575  FAX: (239) 597-0578	SEC: TWP: RGE: 10 47S 25E	HORIZ. SCALE (HALF): 1" = 60'				MMONS CLUB AT THE BROC EBALL FACILITY EXPANSION	~~~~~	
	www.consult-rwa.com Florida Certificates of Authorization	designed: MCP	VERT. SCALE (FULL): N/A	TITLE:		PROJECT NO.:		SHEET NUMBER:	
;		drawn: HGD	VERT. SCALE (HALF): N/A		PHASE 1 CONSTRUCTION	220002.00.02	05 2200020100C CP01	05 OF 8	MICHAEL C. PAPPAS FLORIDA LICENSE NO. 60910

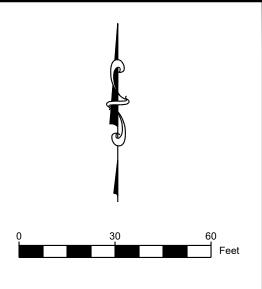


	LEGEND									
EXISTING	PROPOSED	DESCRIPTION								
S-X	s	SANITARY GRAVITY SEWER								
— W-X — — —		WATER MAIN								
— F-X — — —	F	FORCE MAIN								
— I-X — — —		IRRIGATION MAIN								
— FL-X — — —	FL	FIRE MAIN								
— D-X — — —		STORM SEWER								
		SANITARY MANHOLE								
		STORM INLET/JUNCTION BOX								
$\Box$		STORM FLARED END								
$\triangleright$ –	►	CLEAN-OUT (SINGLE)								
○	•	WATER METER								
—M—	<b>—</b>	GATE VALVE								
ゆーン	't'🛖	PARALLEL FIRE HYDRANT ASSEMBLY								
<u>کر</u>	N/A	POWER POLE								
N/A	<b>&amp;</b> G	POWER POLE								
N/A		PROPOSED PAVEMENT								
N/A		PROPOSED BRICK PAVERS								
N/A		PROPOSED PHASE LINE								

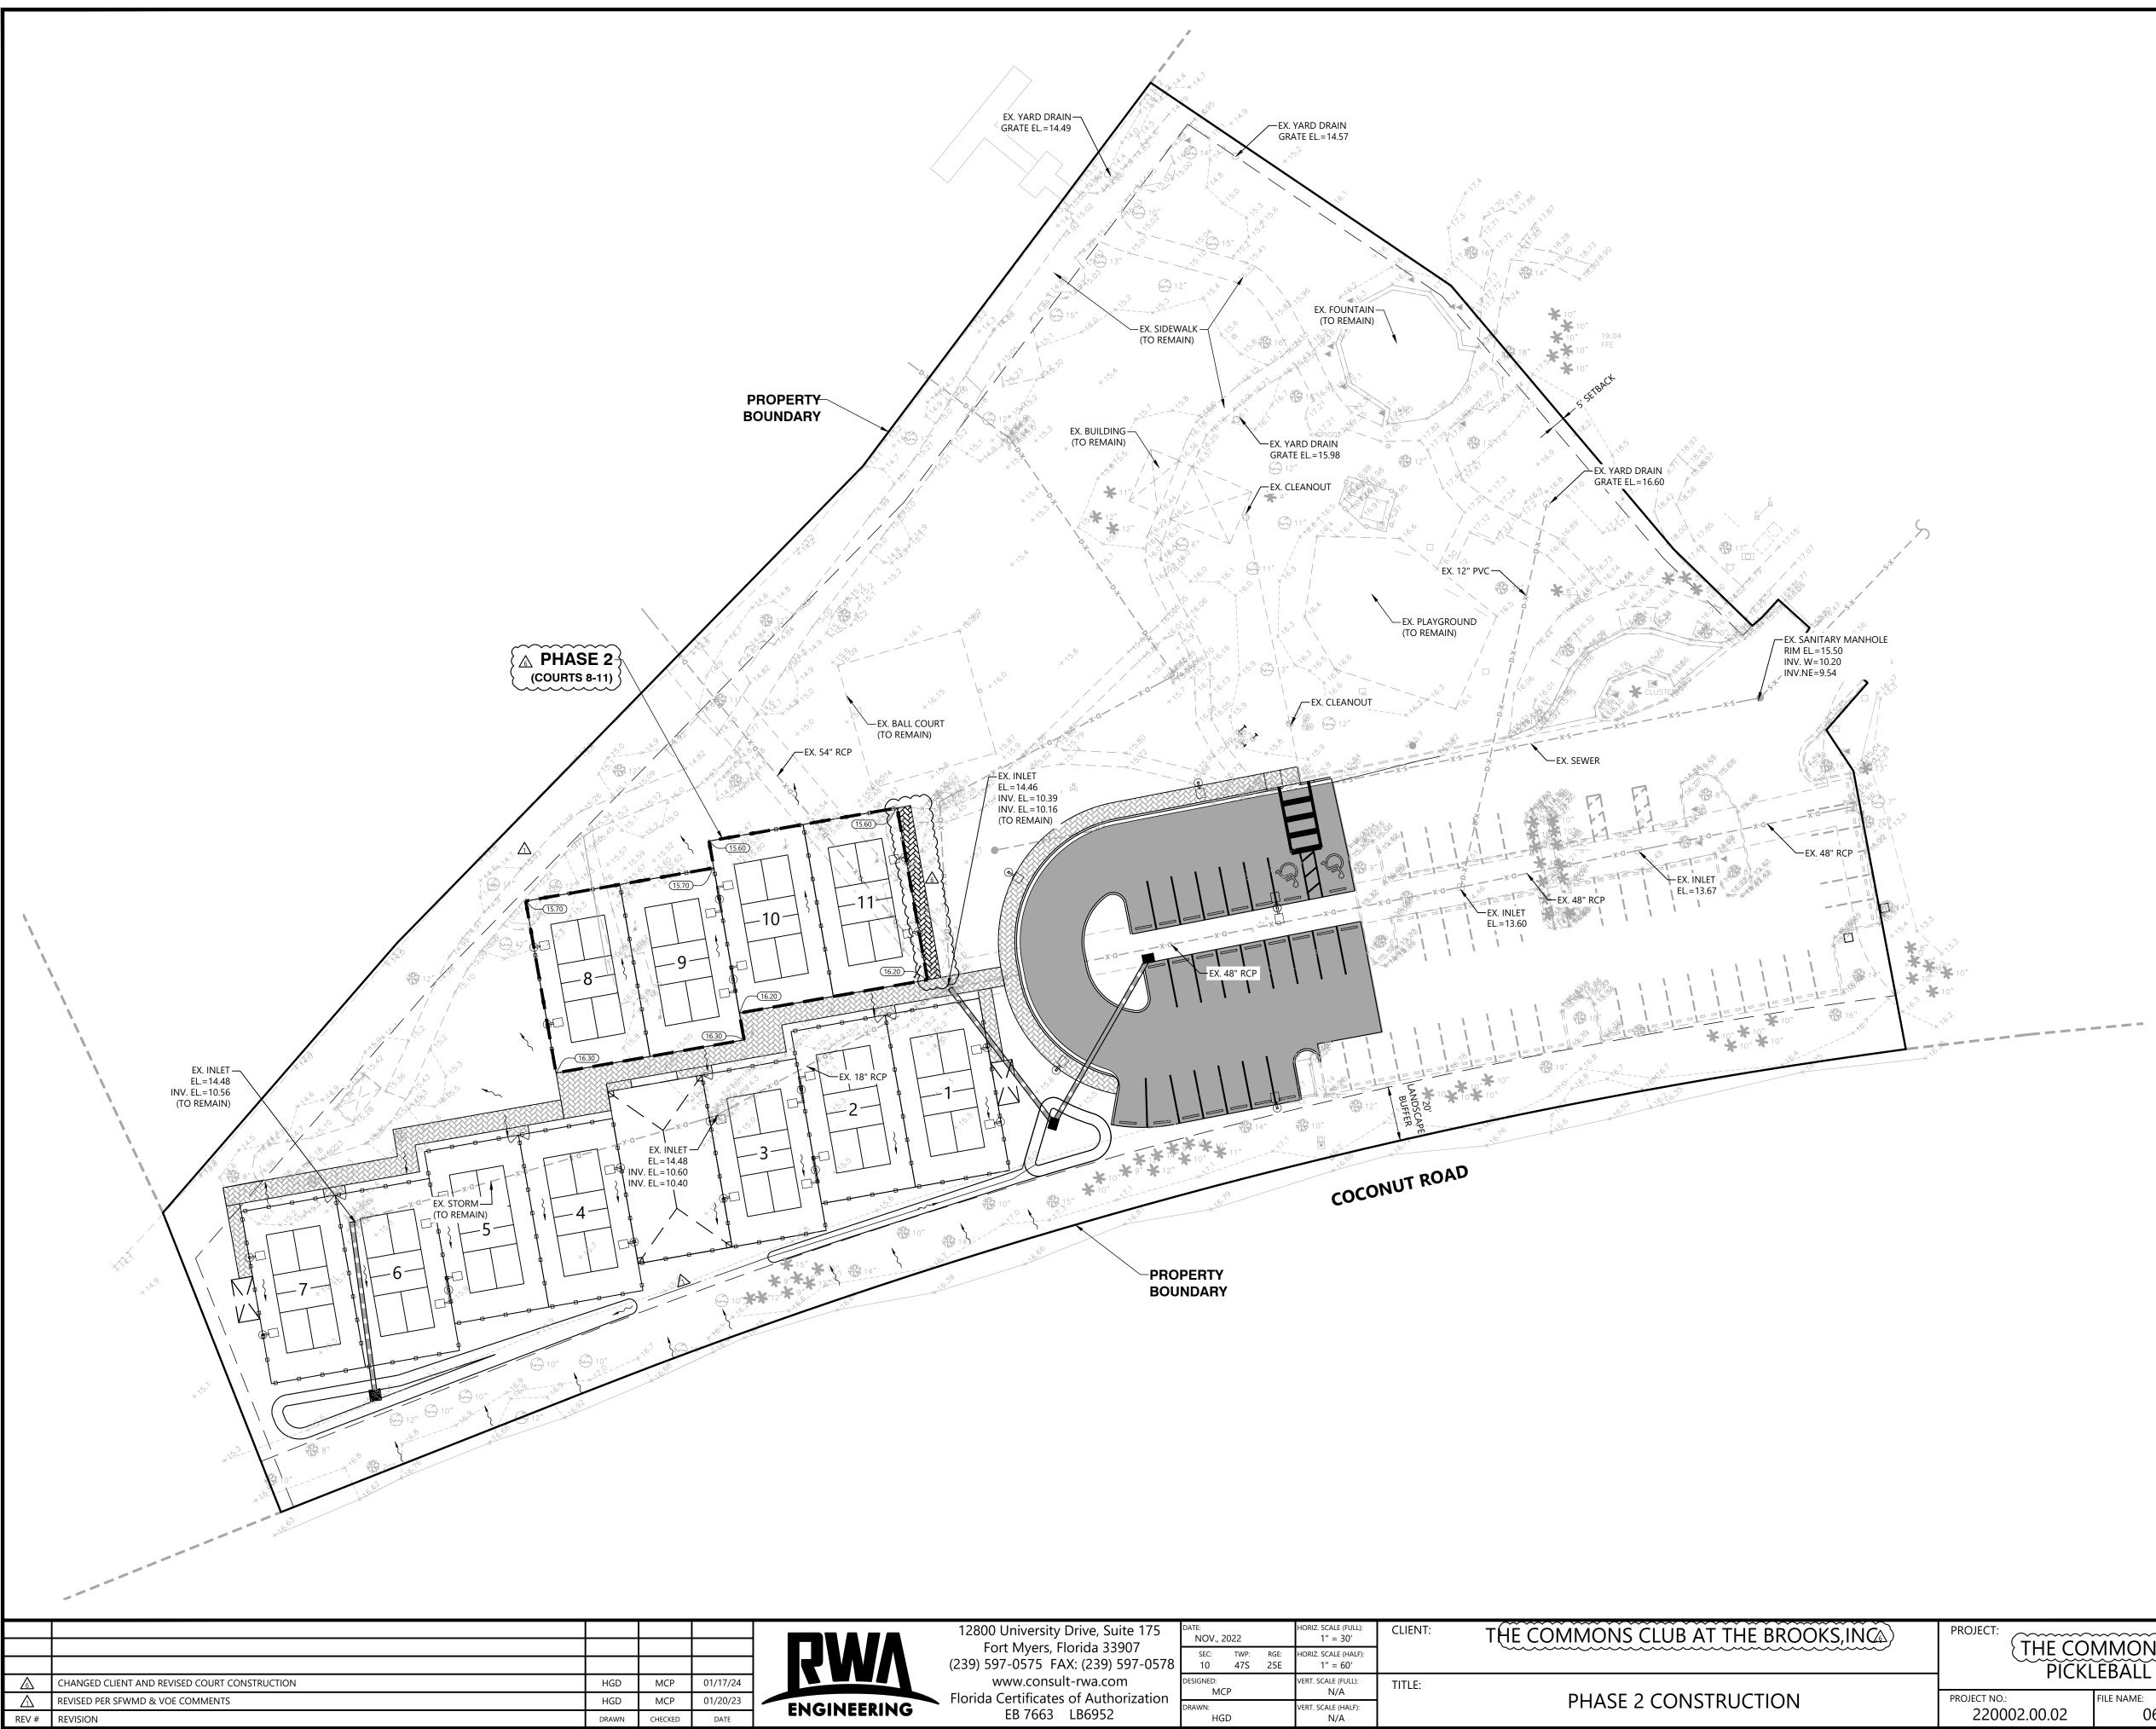


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	12800 University Drive, Suite 175 Fort Myers, Florida 33907 39) 597-0575 FAX: (239) 597-0578	DATE: NOV., 2022 SEC: TWP: RGE: 10 47S 25E	HORIZ. SCALE (FULL): 1" = 30' HORIZ. SCALE (HALF): 1" = 60'	CLIENT:	THE COMMONS CLUB AT THE BROOKS, INCA	FILE CO	MMONS CLUB AT THE BROC	)KS ゐ}	
-	www.consult-rwa.com orida Certificates of Authorization	DESIGNED: MCP DRAWN: HGD	VERT. SCALE (FULL): N/A VERT. SCALE (HALF): N/A	TITLE:	PHASE 2 CONSTRUCTION		FILE NAME: 06 2200020100C CP02	SHEET NUMBER: 06 of 8	MICHAEL C. PAPPAS FLORIDA LICENSE NO. 60910

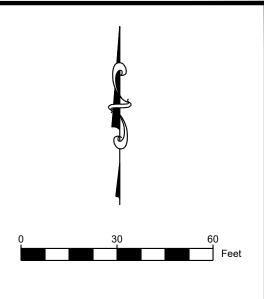

	LEGEND									
EXISTING	PROPOSED	DESCRIPTION								
S-X	s	SANITARY GRAVITY SEWER								
— W-X — — —		WATER MAIN								
— F-X — — —	F	FORCE MAIN								
— I-X — — —		IRRIGATION MAIN								
— FL-X — — —	FL	FIRE MAIN								
— D-X — — —		STORM SEWER								
	<b></b>	SANITARY MANHOLE								
		STORM INLET/JUNCTION BOX								
$\Box$		STORM FLARED END								
$\triangleright$ –	▶	CLEAN-OUT (SINGLE)								
○	•	WATER METER								
	<b>→</b>	GATE VALVE								
	't'🛖	PARALLEL FIRE HYDRANT ASSEMBLY								
<u>,</u>	N/A	POWER POLE								
N/A	\ 🛞 🕞 🗆	POWER POLE								
N/A		PROPOSED PAVEMENT								
N/A		PROPOSED BRICK PAVERS								
N/A		PROPOSED PHASE LINE								

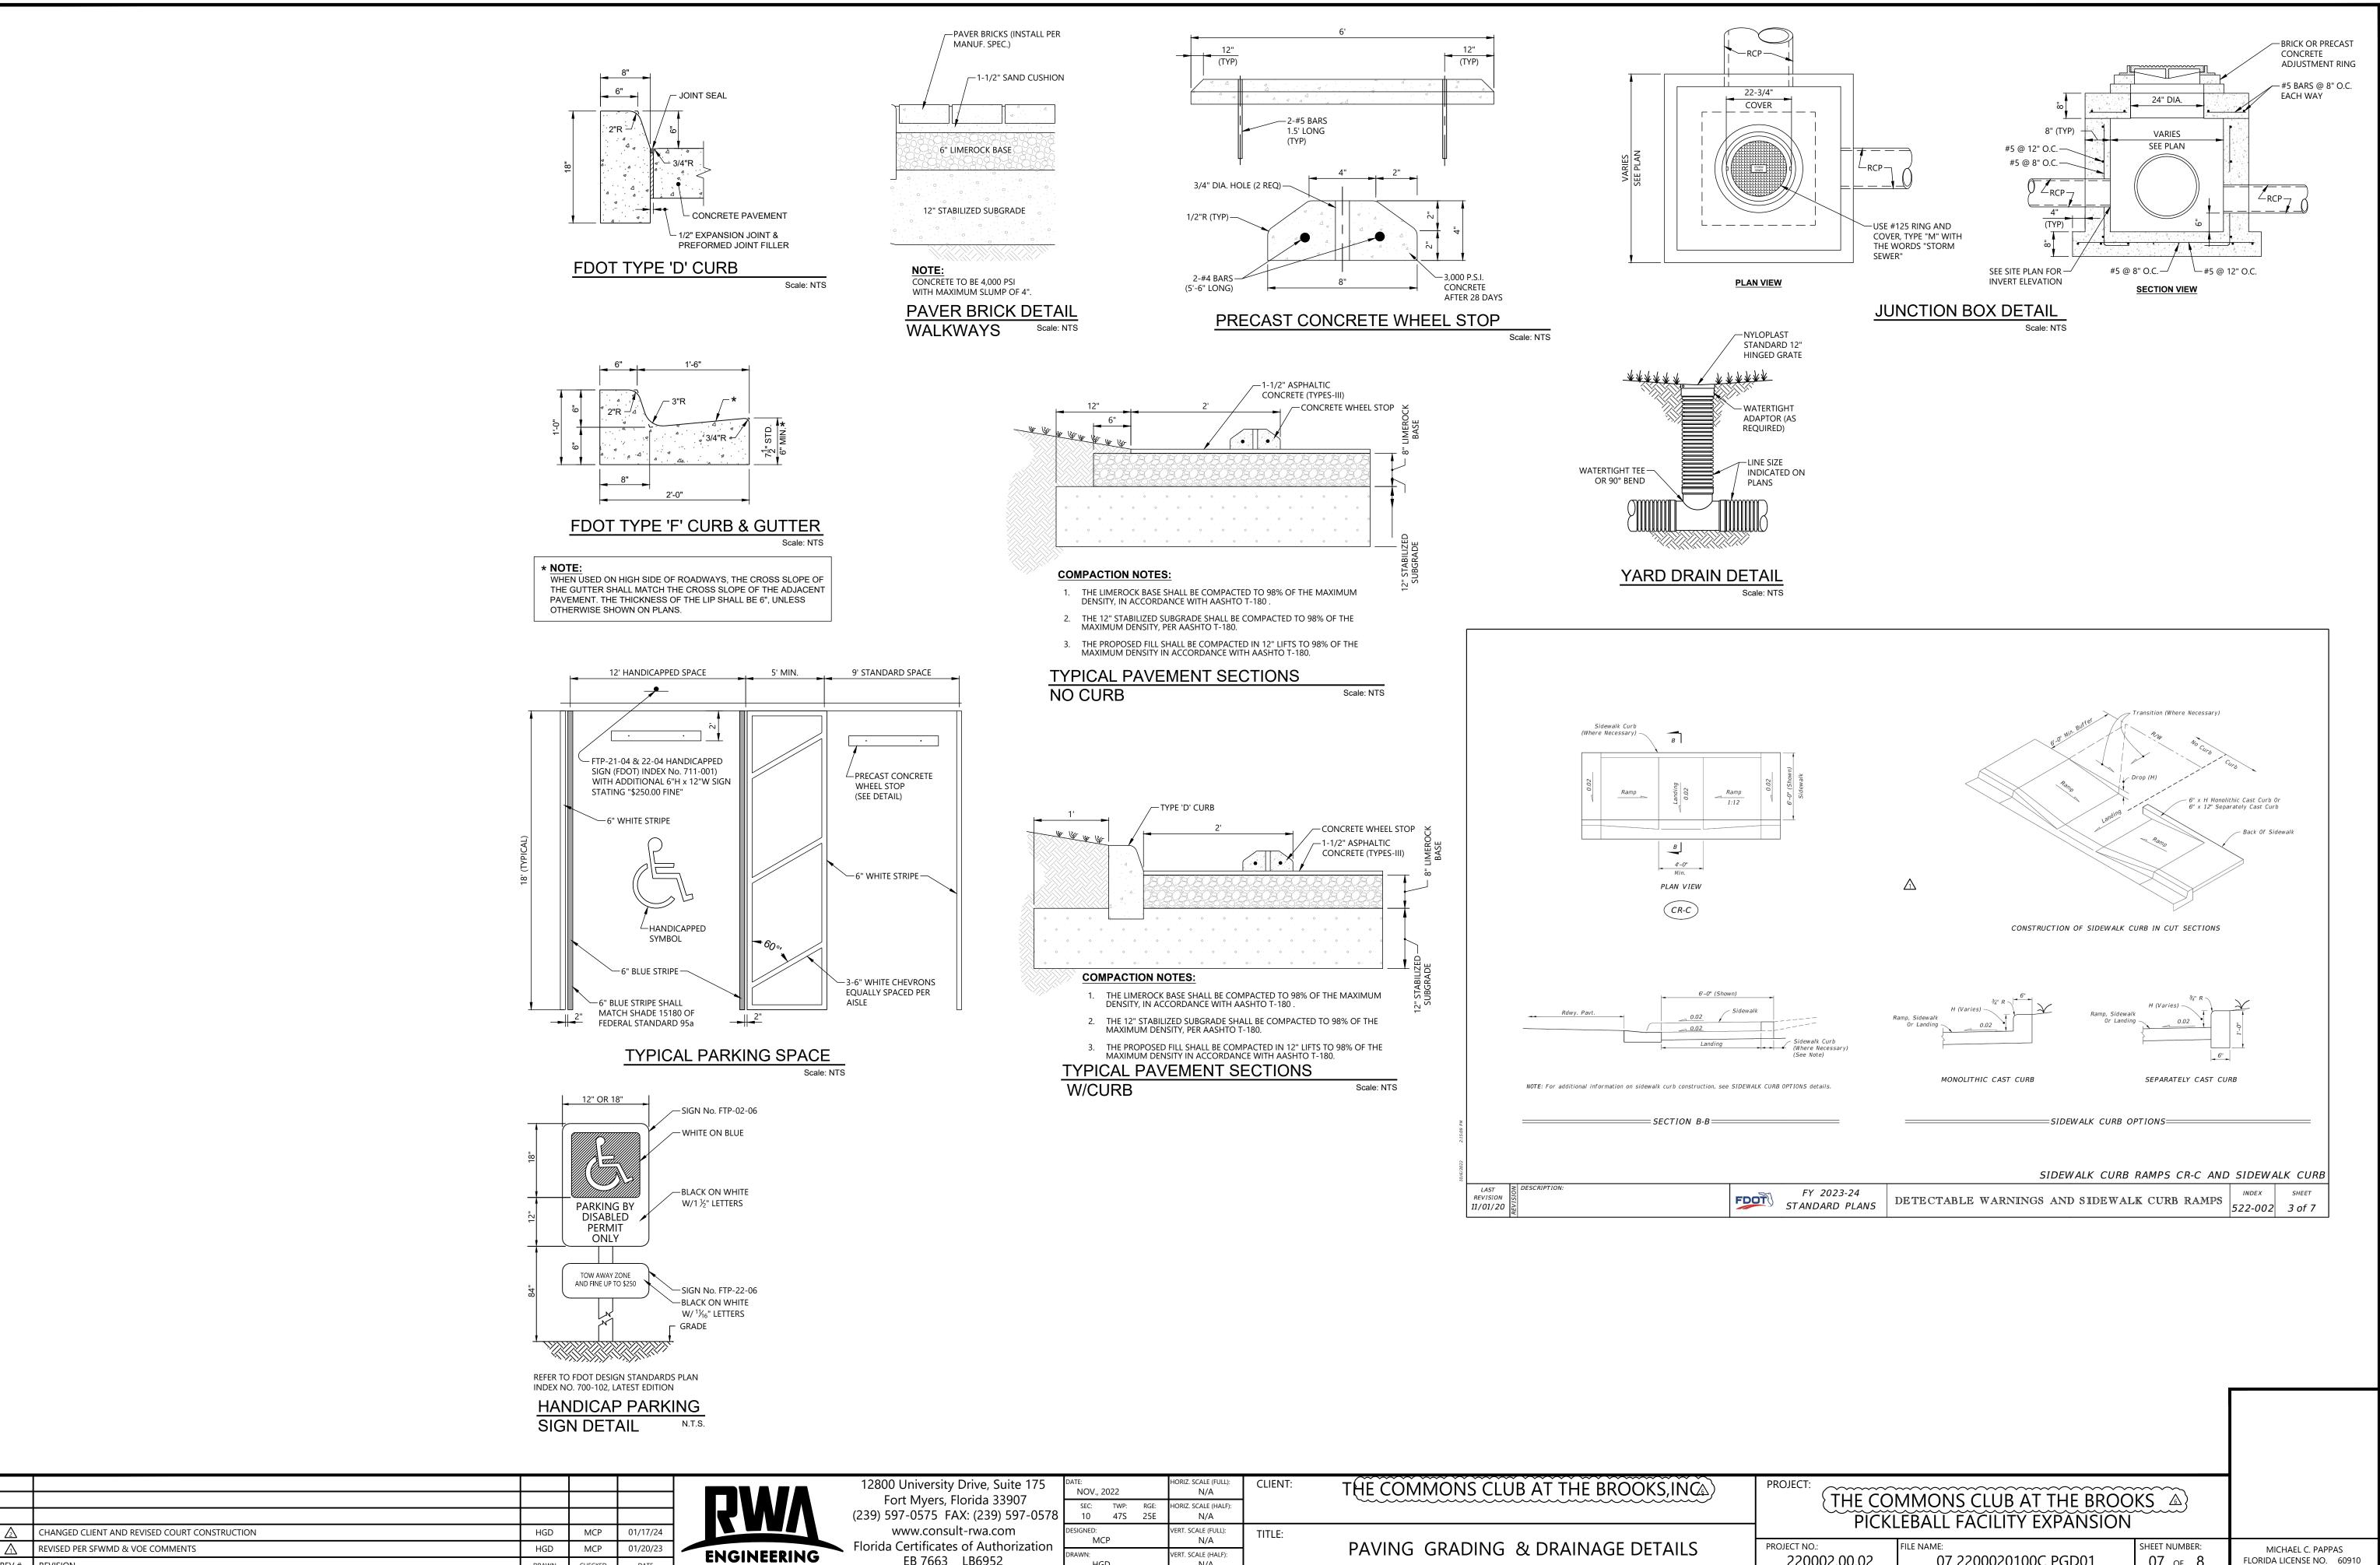

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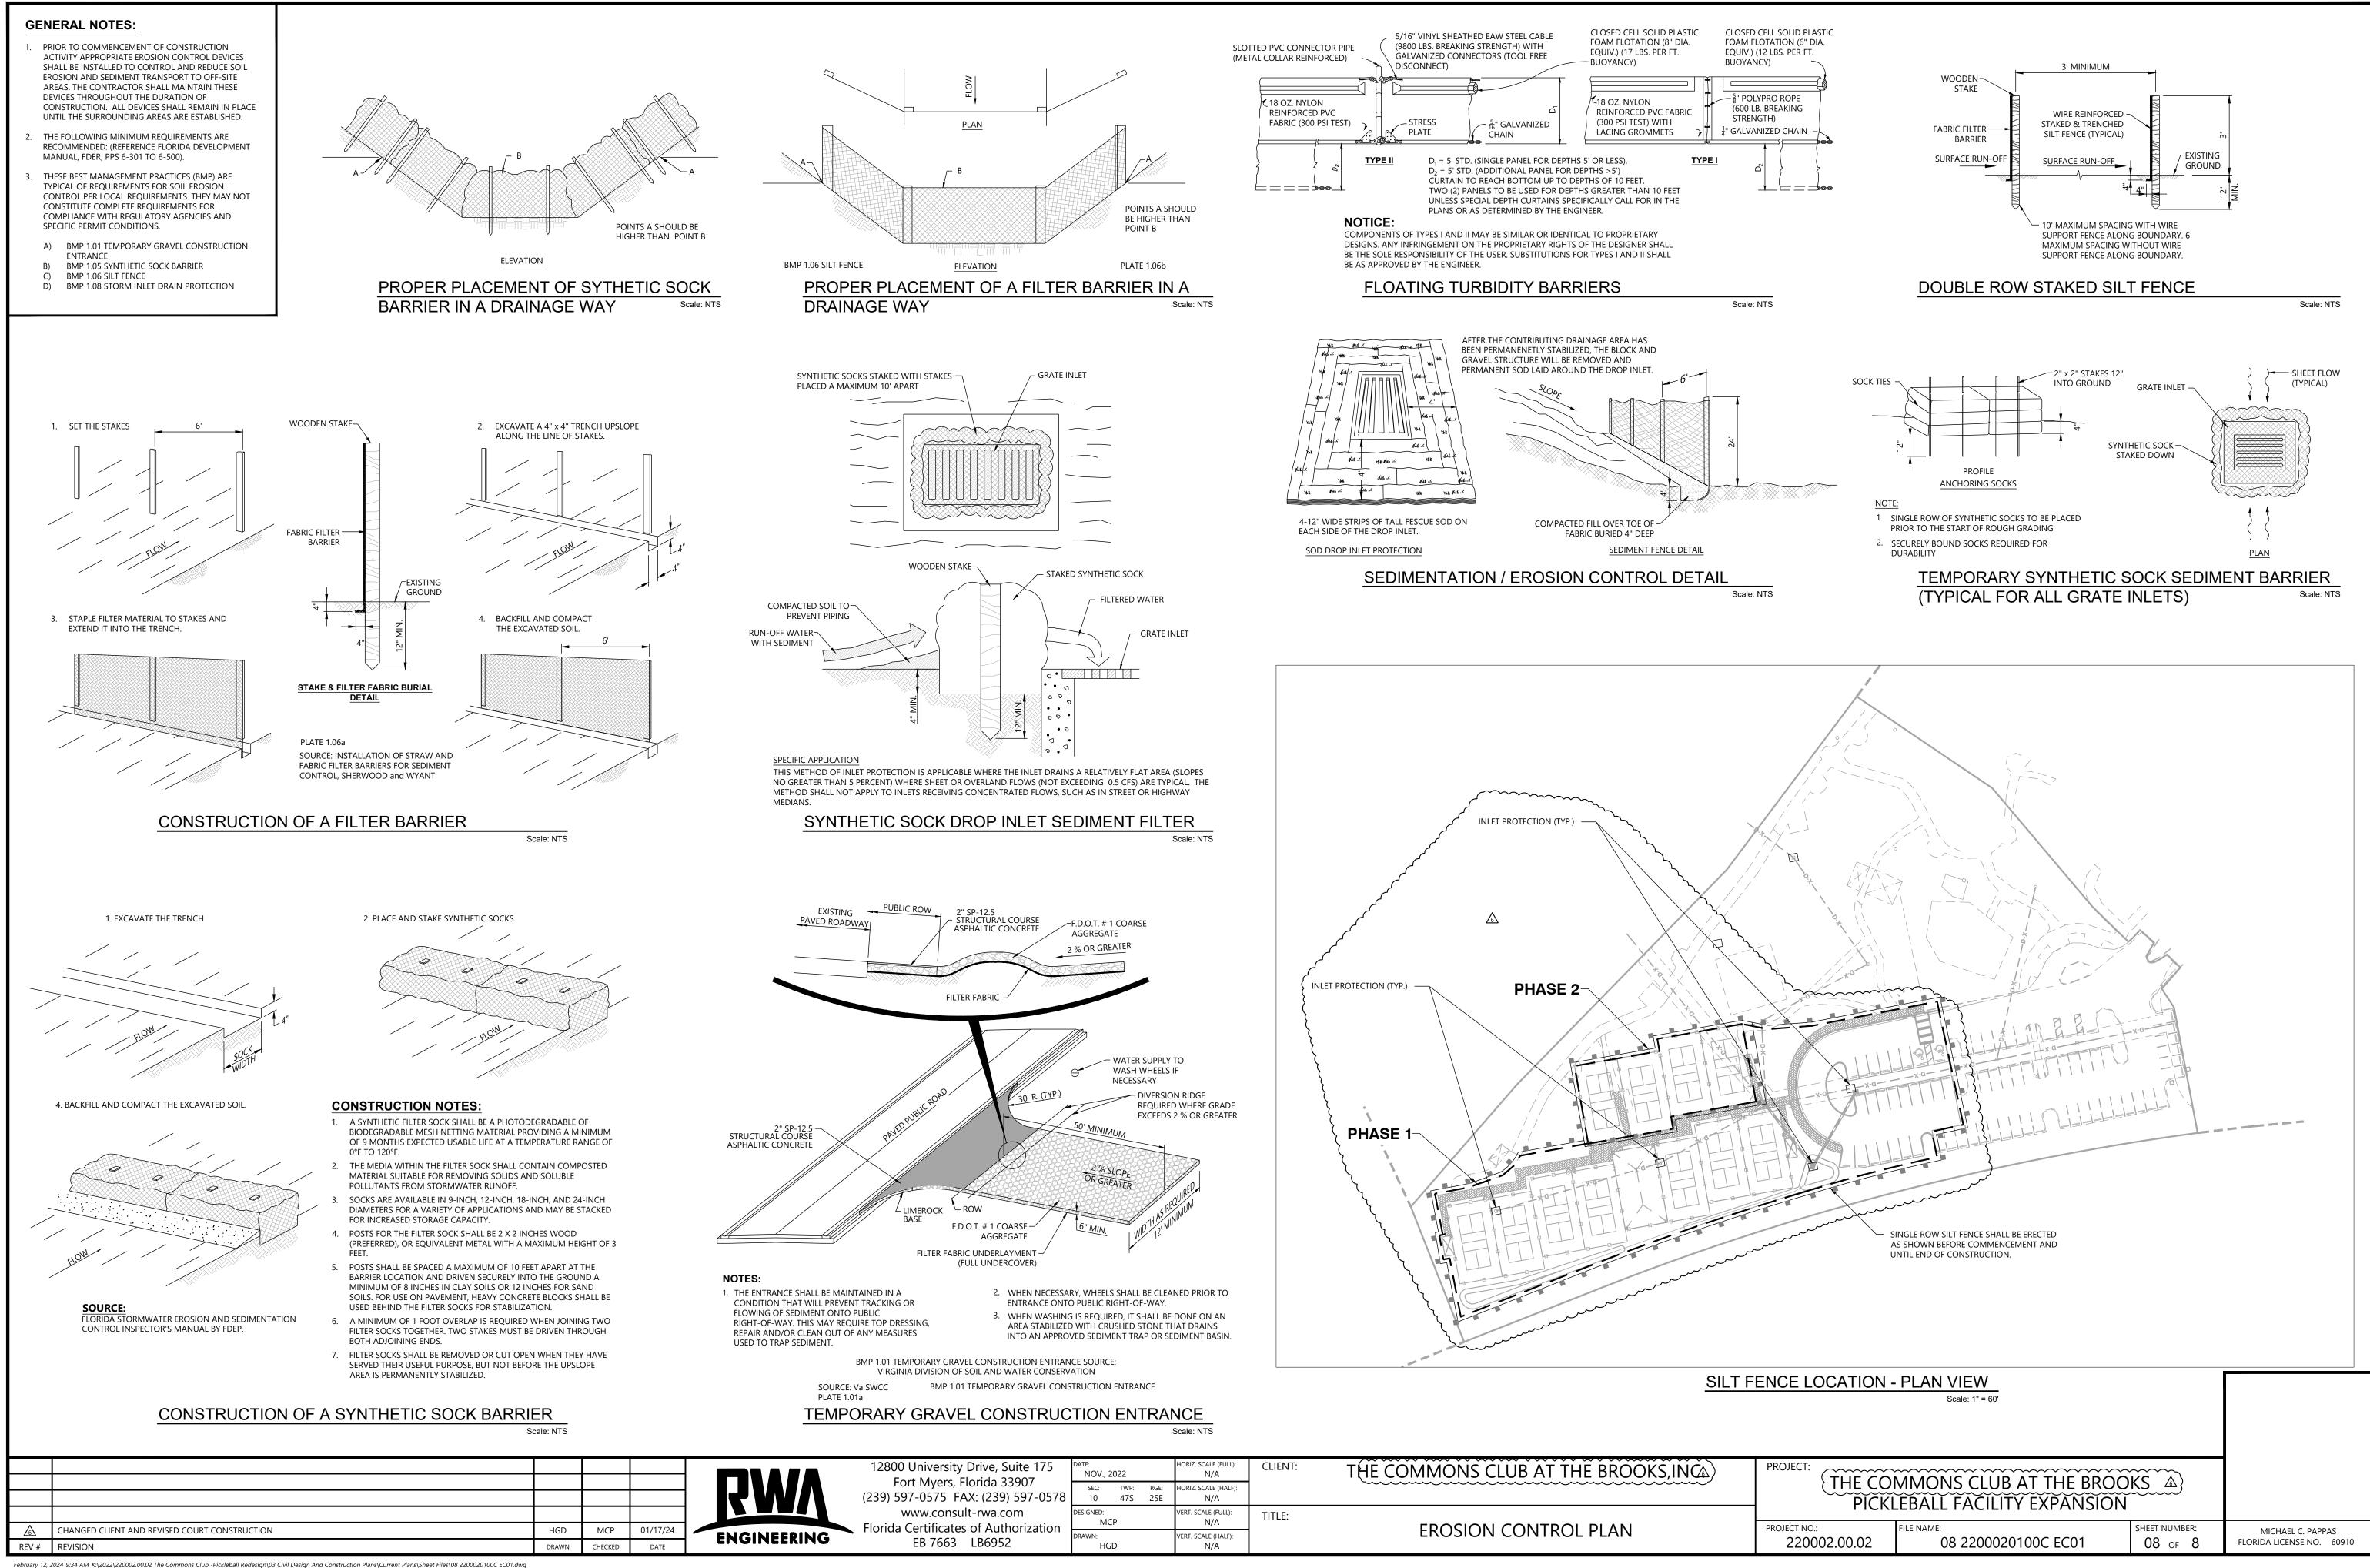
12800 University Drive, Suite 175 Fort Myers, Florida 33907	date: NOV., 20	22	Н	HORIZ. SCALE (FULL): N/A	CLIENT:	THE COMMONS CLUB AT THE BROOKS, INCA)
(239) 597-0575 FAX: (239) 597-0578			GE: Н 5Е	HORIZ. SCALE (HALF): N/A		
www.consult-rwa.com Florida Certificates of Authorization	designed: MCP		V	/ERT. SCALE (FULL): N/A	TITLE:	PAVING GRADING & DRAINAGE DETAILS
EB 7663 LB6952	drawn: HGD		V	/ERT. SCALE (HALF): N/A		PAVING GRADING & DRAINAGE DETAILS

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07 OF 8

FLORIDA LICENSE NO. 60910



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	12800 University Drive, Suite 175 Fort Myers, Florida 33907 (239) 597-0575 FAX: (239) 597-0578		22 TWP: RG 47S 25		CLIENT:	THE COMMONS CLUB AT THE BROOKS, INCA
	www.consult_iwa.com	designed: MCP		VERT. SCALE (FULL): N/A	TITLE:	
;	<ul> <li>Florida Certificates of Authorization EB 7663 LB6952</li> </ul>			vert. scale (half): N/A		EROSION CONTROL PLAN